



# 3700 RIVERSIDE - MIXED USE PROJECT

3700 W. RIVERSIDE DRIVE, BURBANK CA 91505

3700 W. RIVERSIDE  
INVESTMENTS, LLC

CONDITIONAL USE PERMIT & DEVELOPMENT REVIEW RE-SUBMITTAL

SEPTEMBER 30, 2019

STRUERE

**ZONING CODE ANALYSIS**

ADDRESS: 3700 W. RIVERSIDE DRIVE, BURBANK, CA 91505  
 APN: 2485-005-004, 014, 015

ZONE: MDC-3 MEDIA DISTRICT GENERAL BUSINESS  
 DISTRICT: RIVERSIDE DRIVE CORRIDOR

GENERAL PLAN DESIGNATION: MEDIA DISTRICT COMMERCIAL

LOT	DIMENSIONS	EXISTING NEW	250'-0" X 108'-2" 242'-0" X 108'-2"
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AREA	EXISTING PROPOSED DEDICATION FINAL	26,393 SF 966 SF 25,427 SF	0.606 ACRES 0.584 ACRES
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ALLOWABLE DENSITY UNITS	58 /ACRE (W/ CONDITIONAL USE PERMIT)	36 UNITS*
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DENSITY INCREASE BY RIGHT	CRITERIA	INCREASE
STATE AFFORDABLE UNITS	11% VERY LOW	35% 13 UNITS*
TOTAL UNITS		49 UNITS
TOTAL AFFORDABLE UNITS	11% VERY LOW	4 UNITS*

(\*ROUND UP, PER CA DENSITY BONUS GOVT. CODE 65915 (f)(5) & (g))

INCLUSIONARY HOUSING ALLOWABLE UNITS BY RIGHT	36
AFFORDABLE REQUIRED:	15% VERY LOW INCOME: 7.5%
REQUIRED VERY LOW INCOME	3 UNITS

**ALLOWABLE HEIGHT (TO HIGHEST CEILING)**

HEIGHT STORIES	205' (500' MIN. DISTANCE SINGLE FAMILY)
	15

AVERAGE GRADE:	CORNER ELEVS: 552.75', 552.75', 551.94', 551.90'
	AVERAGE ELEV: 552.33'

SETBACK: STREET	AVERAGE 20% OF BLDG. HT., 5' MIN.
ALLEY	0'
R3, R4, R5 COMMERCIAL	5'

ENCROACHMENT:	RETAIL OUTDOOR DINING	50% AREA OF STREET SETBACK FULL ENCROACHMENT
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FAR (COMMERCIAL) ALLOWED:	1.1:1 (OFFICE EQUIVALENT) (NET AREA/TOTAL SITE AREA) 29,085 SF
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**COMMERCIAL PARKING REQUIREMENTS**

PARKING SPACES:	RETAIL 3.3/1,000 SF**
	RESTAURANT/BAR (W/WALK-INS) 10.0/1,000 SF
	(W/WALK-INS) 3.3/1,000 SF**

\*\* 1. RETAIL PARKING REQUIREMENT BASED ON BURBANK ZONING CODE ARTICLE 21, MEDIA DISTRICT OVERLAY ZONE, 10-1-2107(D) MINIMUM PARKING REQUIREMENTS, TABLE 3: RETAIL STORES AND PERSONAL SERVICES - 3.3 SPACES PER 1,000 SF OF ADJUSTED GROSS AREA

\*\* 2. RESTAURANT PARKING REQUIREMENT BASED ON BURBANK ZONING CODE ARTICLE 21, MEDIA DISTRICT OVERLAY ZONE, 10-1-2107(D) MINIMUM PARKING REQUIREMENTS, PARAGRAPH 2: CONDITIONAL USE PERMIT - RESTAURANTS: "...THE CITY MAY APPROVE A REDUCTION IN THE MINIMUM PARKING REQUIREMENT FOR RESTAURANTS WHICH CAN PROVIDE... THAT THE RESTAURANT WILL PRIMARILY SERVE A WALK-IN TRADE..."

LOCATION OF SITE WITHIN 1,000 FEET OF WARNER BROS. STUDIOS AND FOUR HIGH-RISE AND SEVEN MID-RISE OFFICE BUILDINGS AND BURBANK ZONING CODE, ARTICLE 14, GENERAL OFF-STREET PARKING STANDARDS, 10-1-1408.2(h), SPACES REQUIRED: RESTAURANTS...: "...3.3 SPACES FOR EACH 1,000 SQ. FT. OF ADJUSTED GROSS FLOOR AREA WITH AN ADMINISTRATIVE USE PERMIT."

**RESIDENTIAL PARKING REQUIREMENTS (W/ DENSITY BONUS REDUCTION)**

PARKING / UNIT:	STUDIO & 1-BED 1.00 SPACES
	2-BED & 3-BED 2.00 SPACES
	GUEST 0.00 SPACES

COMPACTS: NOT ALLOWED

LOADING:	COMMERCIAL 3,000 SF-15,000 SF 1 SPACE
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BICYCLES 1 SPACE / 5% TOTAL REQ'D VEHICLE SPACES

OPEN SPACE:	COMMON 150 SF/UNIT (80% OPEN TO SKY)
	PRIVATE 50 SF/UNIT (MIN. 5' DIMENSIONS)

MINIMUM STORAGE: 60 SF/UNIT (OUTSIDE OF UNIT)

**BUILDING CODE ANALYSIS**

CONSTRUCTION TYPE	III-A, I-A
OCCUPANCY TYPE	R-2, M
SPRINKLERS*	YES

ALLOWABLE HEIGHT*	85' FROM GRADE
ALLOWABLE STORIES*	5 STORIES ABOVE 1ST FLR. PODIUM
ALLOWABLE AREA PER FLOOR	24,000 SF

\* SPRINKLER BONUS CAN BE USED FOR EITHER INCREASED HEIGHT OR INCREASED AREA. THIS SCHEME USES THE BONUS TO INCREASE HEIGHT.

**PROPOSED DEVELOPMENT**

STATE AFFORDABLE HOUSING BONUS & CITY OF BURBANK T.O.D. BONUS RESIDENTIAL CONDOMINIUMS MIXED-USE PROJECT

RESIDENTIAL (CONDOS)	TYPE	NUMBER	AVG. SIZE	OPEN SPACE	PRKG REQ'D*
	1-BED	18	937 GSF	18 X 150 SF	18 (1/UNIT)
	2-BED	27	1,442 GSF	27 X 150 SF	54 (2/UNIT)
	3-BED	4	2,187 GSF	4 X 150 SF	8 (2/UNIT)
	TOTAL	49	1,317 GSF	7,350 SF NET	80

(\*PER PER CA DENSITY BONUS GOVT. CODE 65915 (p)(1))

COMMERCIAL BLDG. USE	SIZE	PRKG. REQ'D	PRKG. REQ'D
RESTAURANT/RETAIL	2,000 SF	5.0/1,000	10

PARKING CODE REQUIRED PROJECT PROVIDED EXTRA PARKING	90 SPACES 90 SPACES 0 SPACE
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ADA PARKING RESIDENTIAL	REQUIRED PROVIDED	4 SPACES 4 SPACES
COMMERCIAL	REQUIRED PROVIDED	1 SPACE 1 SPACE

BICYCLES REQUIRED BIKE PARKING: PROVIDED BIKE PARKING:	5% OF REQ'D VEHICLE PRKG. 5 SPACES 3 RACKS 2 SPACES/RACK 6 SPACES
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**BUILDING PARAMETERS**

BUILDING HEIGHT	ZONING: 78'-8" (GRADE TO HIGHEST CEILING)
	BLDG DEPT. 80'-0" (GRADE TO AVERAGE ROOF)
	(LOW ROOF: 70'-4", HIGH ROOF: 80'-0", ELEVTR.: 83'-0")

STREET SETBACK GENERAL	MIN: 5'-0" AVER.: 15'-9" (20% OF BLDG. HT.)
	1ST FLR. RETAIL AVER: 7'-11" (50% ENCROACHMENT)
	SETBACK HEIGHT: 20'-0"

\* PER ARTICLE 7 COMMERCIAL USES AND STANDARDS, PARAGRAPH 10-1-705(C)2a: "...SUCH SETBACKS SHALL BE REQUIRED FOR THAT PORTION OF A BUILDING THAT IS WITHIN 20 FEET ABOVE GRADE..."

**PROJECT AREA**

EXISTING STRUCTURES TO BE DEMOLISHED	1,628 SF
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GROSS USABLE AREA - COMMERCIAL*	FIRST FLOOR 2,000 SF
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GROSS USABLE AREA - RESIDENTIAL*	SECOND FLOOR 11,482 SF THIRD FLOOR 12,821 SF FOURTH FLOOR 12,817 SF FIFTH FLOOR 12,269 SF SIXTH FLOOR 12,368 SF MEZZANINE 3,077 SF TOTAL 64,834 SF
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GROSS USABLE AREA - TOTAL	66,834 SF
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GROSS BUILDING AREA - COMMERCIAL	GROUND FLOOR: 2,141 SF TOTAL COMMERCIAL 2,141 SF
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GROSS BUILDING AREA - RESIDENTIAL	FIRST FLOOR 3,008 SF SECOND FLOOR 13,065 SF THIRD FLOOR 14,685 SF FOURTH FLOOR 14,689 SF FIFTH FLOOR 13,820 SF SIXTH FLOOR 13,985 SF MEZZANINE 7,330 SF TOTAL 80,582 SF
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GROSS BUILDING AREA - TOTAL	82,723 SF
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FAR AREA**	GROUND FLOOR 2,000 SF TOTAL 2,000 SF FAR 1:0.076
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\* GROSS USABLE AREA INCLUDES EXTERIOR, CORRIDOR & PARTY WALLS, BUT EXCLUDES CORRIDORS, STAIRS AND ELEVATORS.

\*\* GROSS FLOOR AREA, FOR THE PURPOSE OF CALCULATING FAR & PARKING EXCLUDES EXTERIOR WALLS, PERMANENT INTERIOR WALLS, COLUMNS, MECHANICAL ROOMS AND STAIR, ELEVATOR & DUCT SHAFTS. INCLUDED ARE CORRIDORS & RESTROOMS

COMMON OPEN SPACE	REQUIRED: TOTAL UNCOVERED (80%) 7,350 SF PROVIDED: 1ST (1,253 SF) 1,964 SF 2ND (2,916 SF) 3,743 SF ROOF (4,959 SF) 4,973 SF
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PRIVATE OPEN SPACE	REQUIRED: 50 SF/UNIT 2,450 SF PROVIDED (CONFORMING): 9,506 SF PROVIDED (NON-CONFORMING): 1,432 SF PROVIDED (TOTAL): 10,938 SF
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LOT COVERAGE WAIVER:	REQUIRED: 70% MAXIMUM 17,799 SF 80% MAXIMUM 20,341 SF PROVIDED: 20,341 SF
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PRIVATE STORAGE	REQUIRED: 49 x 60 CF/UNIT 2,940 CF 4,045 CF
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**PROJECT DESCRIPTION**

A NEW SIX-STORY MIXED-USE BUILDING REPLACING AN EXISTING GAR WASH, CONSISTING OF 49 RESIDENTIAL CONDOMINIUMS AND 2,000 SF OF COMMERCIAL SPACE.

A TYPE III-A WOOD FRAME STRUCTURE OVER A TYPE-1A CONCRETE PODIUM AT GROUND FLOOR & ONE UNDERGROUND LEVEL.

**PROJECT DESCRIPTION**

---	ADA PATH OF TRAVEL
▨	PRIVATE OPEN SPACE (CONFORMING)
▧	PRIVATE OPEN SPACE (NON. CONFORM.)
■	LOW GROUND COVER
■	HIGH PLANTER
■	BWP CLEARANCE AREA
■	WATER FEATURE

**ARCHITECTURE**

- COVER SHEET
- A0.1 GENERAL INFORMATION
- A0.2 SETBACK PLANS
- A0.5 AERIAL VIEWS
- A0.6 CORNER VIEWS
- A0.7 FRONT VIEWS
- A0.8 PEDESTRIAN VIEWS
- A0.9 ROOF DECK & POCKET PARK VIEWS
- A1.1 SITE PLAN
- A2.0 PARKING LEVEL PLAN
- A2.1 GROUND FLOOR PLAN
- A2.2 SECOND FLOOR PLAN
- A2.3 THIRD FLOOR PLAN
- A2.4 FOURTH FLOOR PLAN
- A2.5 FIFTH FLOOR PLAN
- A2.6 SIXTH FLOOR PLAN
- A2.7 MEZZANINE LEVEL & ROOF PLAN
- A2.8 UPPER ROOF PLAN
- A3.1 NORTH ELEVATION
- A3.2 EAST & WEST ELEVATIONS
- A3.3 SOUTH ELEVATION
- A4.1 BUILDING SECTION
- A5.1 MATERIAL SCHEDULE

**SURVEY**  
 000 SURVEY


**CIVIL**  
 C01 TITLE SHEET & GENERAL NOTES  
 C02 SITE DEMOLITION PLAN  
 C04 ROUGH GRADING & EXCAVATION PLAN  
 C05 PRECISE GRADING & DRAINAGE PLAN  
 C07 SUSMP EXHIBIT

**LANDSCAPE**  
 L1.1 GROUND FLOOR LANDSCAPE PLAN  
 L1.2 SECOND FLOOR LANDSCAPE PLAN  
 L1.3 MEZZANINE/ROOF LANDSCAPE PLAN


**MECHANICAL**  
 M1.0 MECHANICAL GROUND FLOOR PLAN  
 M2.0 MECHANICAL PARKING LEVEL PLAN

**LIGHTING**  
 L1.1 SITE LIGHTING PLAN

**ELECTRICAL**  
 E1.0 NOTES & SYMBOLS  
 E2.0 SINGLE LINE DIAGRAM & LOAD CALCS.  
 E2.1 SWITCH BOARD ELEVATIONS  
 E4.0 PARKING ELECTRICAL PLAN  
 E4.1 GROUND FLOOR ELECTRICAL PLAN

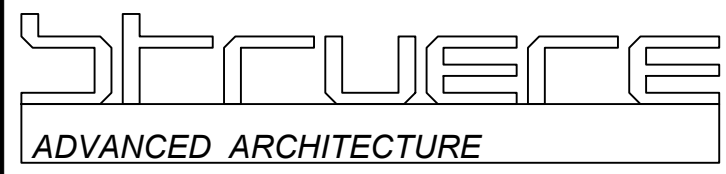

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**PROJECT DIRECTORY**

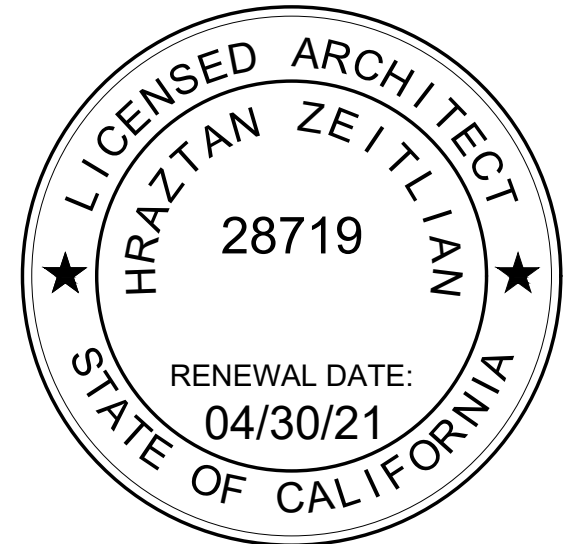- Existing Residential: No residential units currently exist on the Project Site
- Project will comply with Section 10-1-1113.1(F) of the BMC: "All appendages ... and Marquees shall be flame resistant or erected with non-combustible materials that meet [CA Fire Code] requirements, and shall not protrude far enough to obstruct a ladder placed at ground level at a 70 degree angle to the building openings above the appendage ... or marquees.
- Glass guardrails, doors and windows facing MDR4 property will be max. 15% reflective at guard rails and ground floor and max. 8% reflective elsewhere
- Lot Area shall be min.15% Landscape. Common Open Space shall be min. 15% landscape. See Landscape Plan, L1.1 for more information.
- Common Open Space shall provide one tree per 600 sf. Street facing perimeters shall provide one tree per 20 feet. See Landscape Plan, L1.1 for more information.

**GENERAL NOTES**

- WAIVER #1 - ROOFTOP COMMON OPEN SPACE PERCENTAGE**  
To allow Roof Deck to fulfill Common Open Space requirements
- WAIVER #2 - OPAQITY & HEIGHT OF ROOFTOP COMMON OPEN SPACE ENCLOSURE WALLS**  
To allow a 42" high transparent guard rail at the Roof Deck
- WAIVER #3 - SETBACK OF ROOFTOP COMMON OPEN SPACE ENCLOSURE WALLS**  
To allow the Roof Deck enclosure aligned with building face.
- WAIVER #4 - OPAQITY OF PRIVATE OPEN SPACE ENCLOSURE WALLS**  
To allow a transparent guard rail at the Balconies
- WAIVER #5 - LOT COVERAGE**  
To allow an increase of Lot Coverage to 80% of Project Site
- WAIVER #6 - SETBACK ADJACENT TO RESIDENTIAL ZONE**  
To allow structure and parking up to the property line adjacent to a property zoned as MDR4.

UNIT	BEDS	GROSS AREA	OPEN SPACE		STORAGE	PRICING
			CONFORMING	NON-CONF		
201	2	1,218 SF	63 SF	43 SF	80 CF	MARKET
202	1	924 SF	78 SF		72 CF	MARKET
203	2	1,392 SF	68 SF		64 CF	MARKET
204	1	945 SF	78 SF		73 CF	MARKET
205	2	1,201 SF	215 SF	43 SF	144 CF	MARKET
206	2	1,521 SF	70 SF		82 CF	MARKET
207	1	993 SF	74 SF		82 CF	MARKET
208	2	1,240 SF	83 SF		82 CF	AFFORDABLE
209	1	842 SF	68 SF		68 CF	AFFORDABLE
210	2	1,206 SF	72 SF		71 CF	MARKET
		11,482 SF	869 SF	86 SF		
301	2	1,531 SF	190 SF	68 SF	84 CF	MARKET
302	1	1,010 SF	69 SF		68 CF	MARKET
303	2	1,544 SF	156 SF	36 SF	123 CF	MARKET
304	1	944 SF	78 SF		79 CF	MARKET
305	2	1,538 SF	174 SF	56 SF	88 CF	MARKET
306	2	1,715 SF	68 SF	97 SF	82 CF	MARKET
307	1	948 SF	155 SF		82 CF	MARKET
308	2	1,291 SF	63 SF	40 SF	82 CF	AFFORDABLE
309	1	842 SF	80 SF		67 CF	AFFORDABLE
310	2	1,458 SF	50 SF		71 CF	MARKET
		12,821 SF	1,083 SF	297 SF		
401	2	1,521 SF	214 SF	56 SF	84 CF	MARKET
402	1	1,010 SF	71 SF		68 CF	MARKET
403	2	1,545 SF	150 SF	35 SF	123 CF	MARKET
404	1	944 SF	77 SF		79 CF	MARKET
405	2	1,543 SF	179 SF	53 SF	88 CF	MARKET
406	2	1,715 SF	68 SF	97 SF	82 CF	MARKET
407	1	948 SF	66 SF		82 CF	MARKET
408	2	1,291 SF	50 SF	41 SF	82 CF	MARKET
409	1	842 SF	72 SF		68 CF	MARKET
410	2	1,458 SF	50 SF		71 CF	MARKET
		12,817 SF	997 SF	282 SF		
501	2	1,342 SF	351 SF	155 SF	84 CF	MARKET
502	1	925 SF	71 SF	44 SF	166 CF	MARKET
503	2	1,651 SF	195 SF		123 CF	MARKET
504	1	944 SF	123 SF		79 CF	MARKET
505	2	1,386 SF	484 SF	39 SF	88 CF	MARKET
506	2	1,574 SF	226 SF	107 SF	82 CF	MARKET
507	1	948 SF	73 SF		82 CF	MARKET
508	2	1,393 SF	69 SF		82 CF	MARKET
509	1	842 SF	90 SF		68 CF	MARKET
510	2	1,264 SF	144 SF	135 SF	71 CF	MARKET
		12,269 SF	1,826 SF	480 SF		
601	3	1,872 SF	526 SF	196 SF	66	











PEDESTRIAN VIEW LOOKING EAST

4



PEDESTRIAN VIEW LOOKING NORTHEAST

3



PEDESTRIAN VIEW LOOKING NORTHWEST

2




PEDESTRIAN VIEW LOOKING WEST

1

**struere**  
ADVANCED ARCHITECTURE

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3700 RIVERSIDE  
DRIVE  
MIXED-USE  
PROJECT

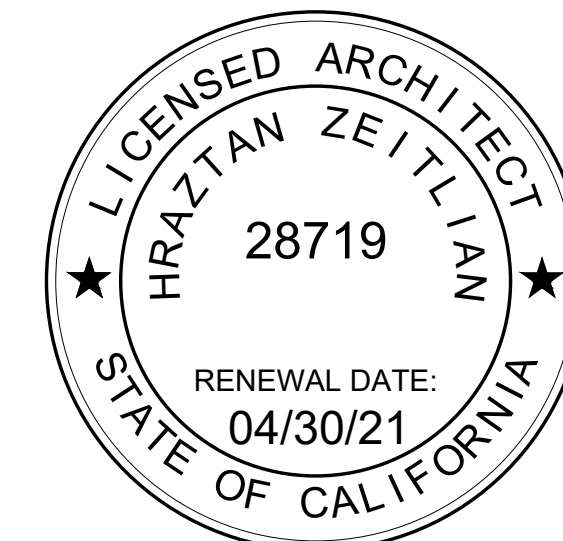3700 W. RIVERSIDE DRIVE  
BURBANK, CA 91505

CUP & DR SUBMITTAL	2/15/19
CUP & DR RE-SUBMITTAL	9/30/19

ISSUE DESCRIPTION

SHEET TITLE

**PEDESTRIAN  
VIEWS**


SHEET NUMBER

**A0.8**







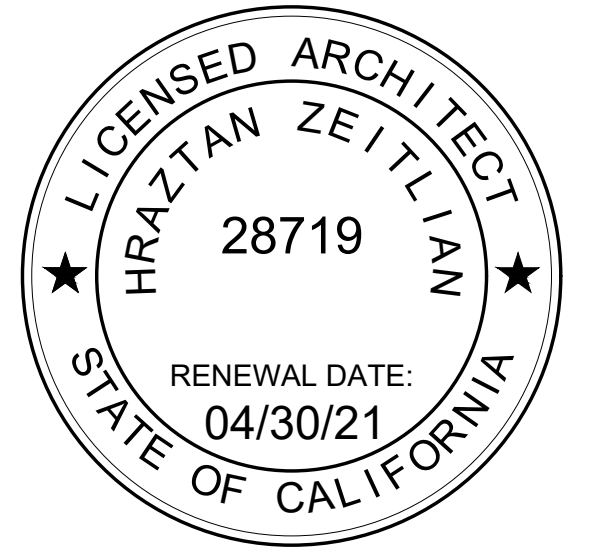

3700 W. RIVERSIDE INVESTMENTS, LLC  
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3700 RIVERSIDE DRIVE MIXED-USE PROJECT

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BURBANK, CA 91505

CUP & DR SUBMITTAL	2/15/19
CUP & DR RE-SUBMITTAL	9/30/19


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SHEET TITLE

**PARKING LEVEL PLAN**

SHEET NUMBER


**A2.0**

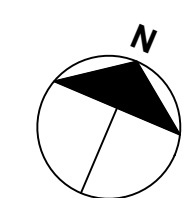

SCALE  
1/8"=1'-0"

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PARKING LEVEL PLAN



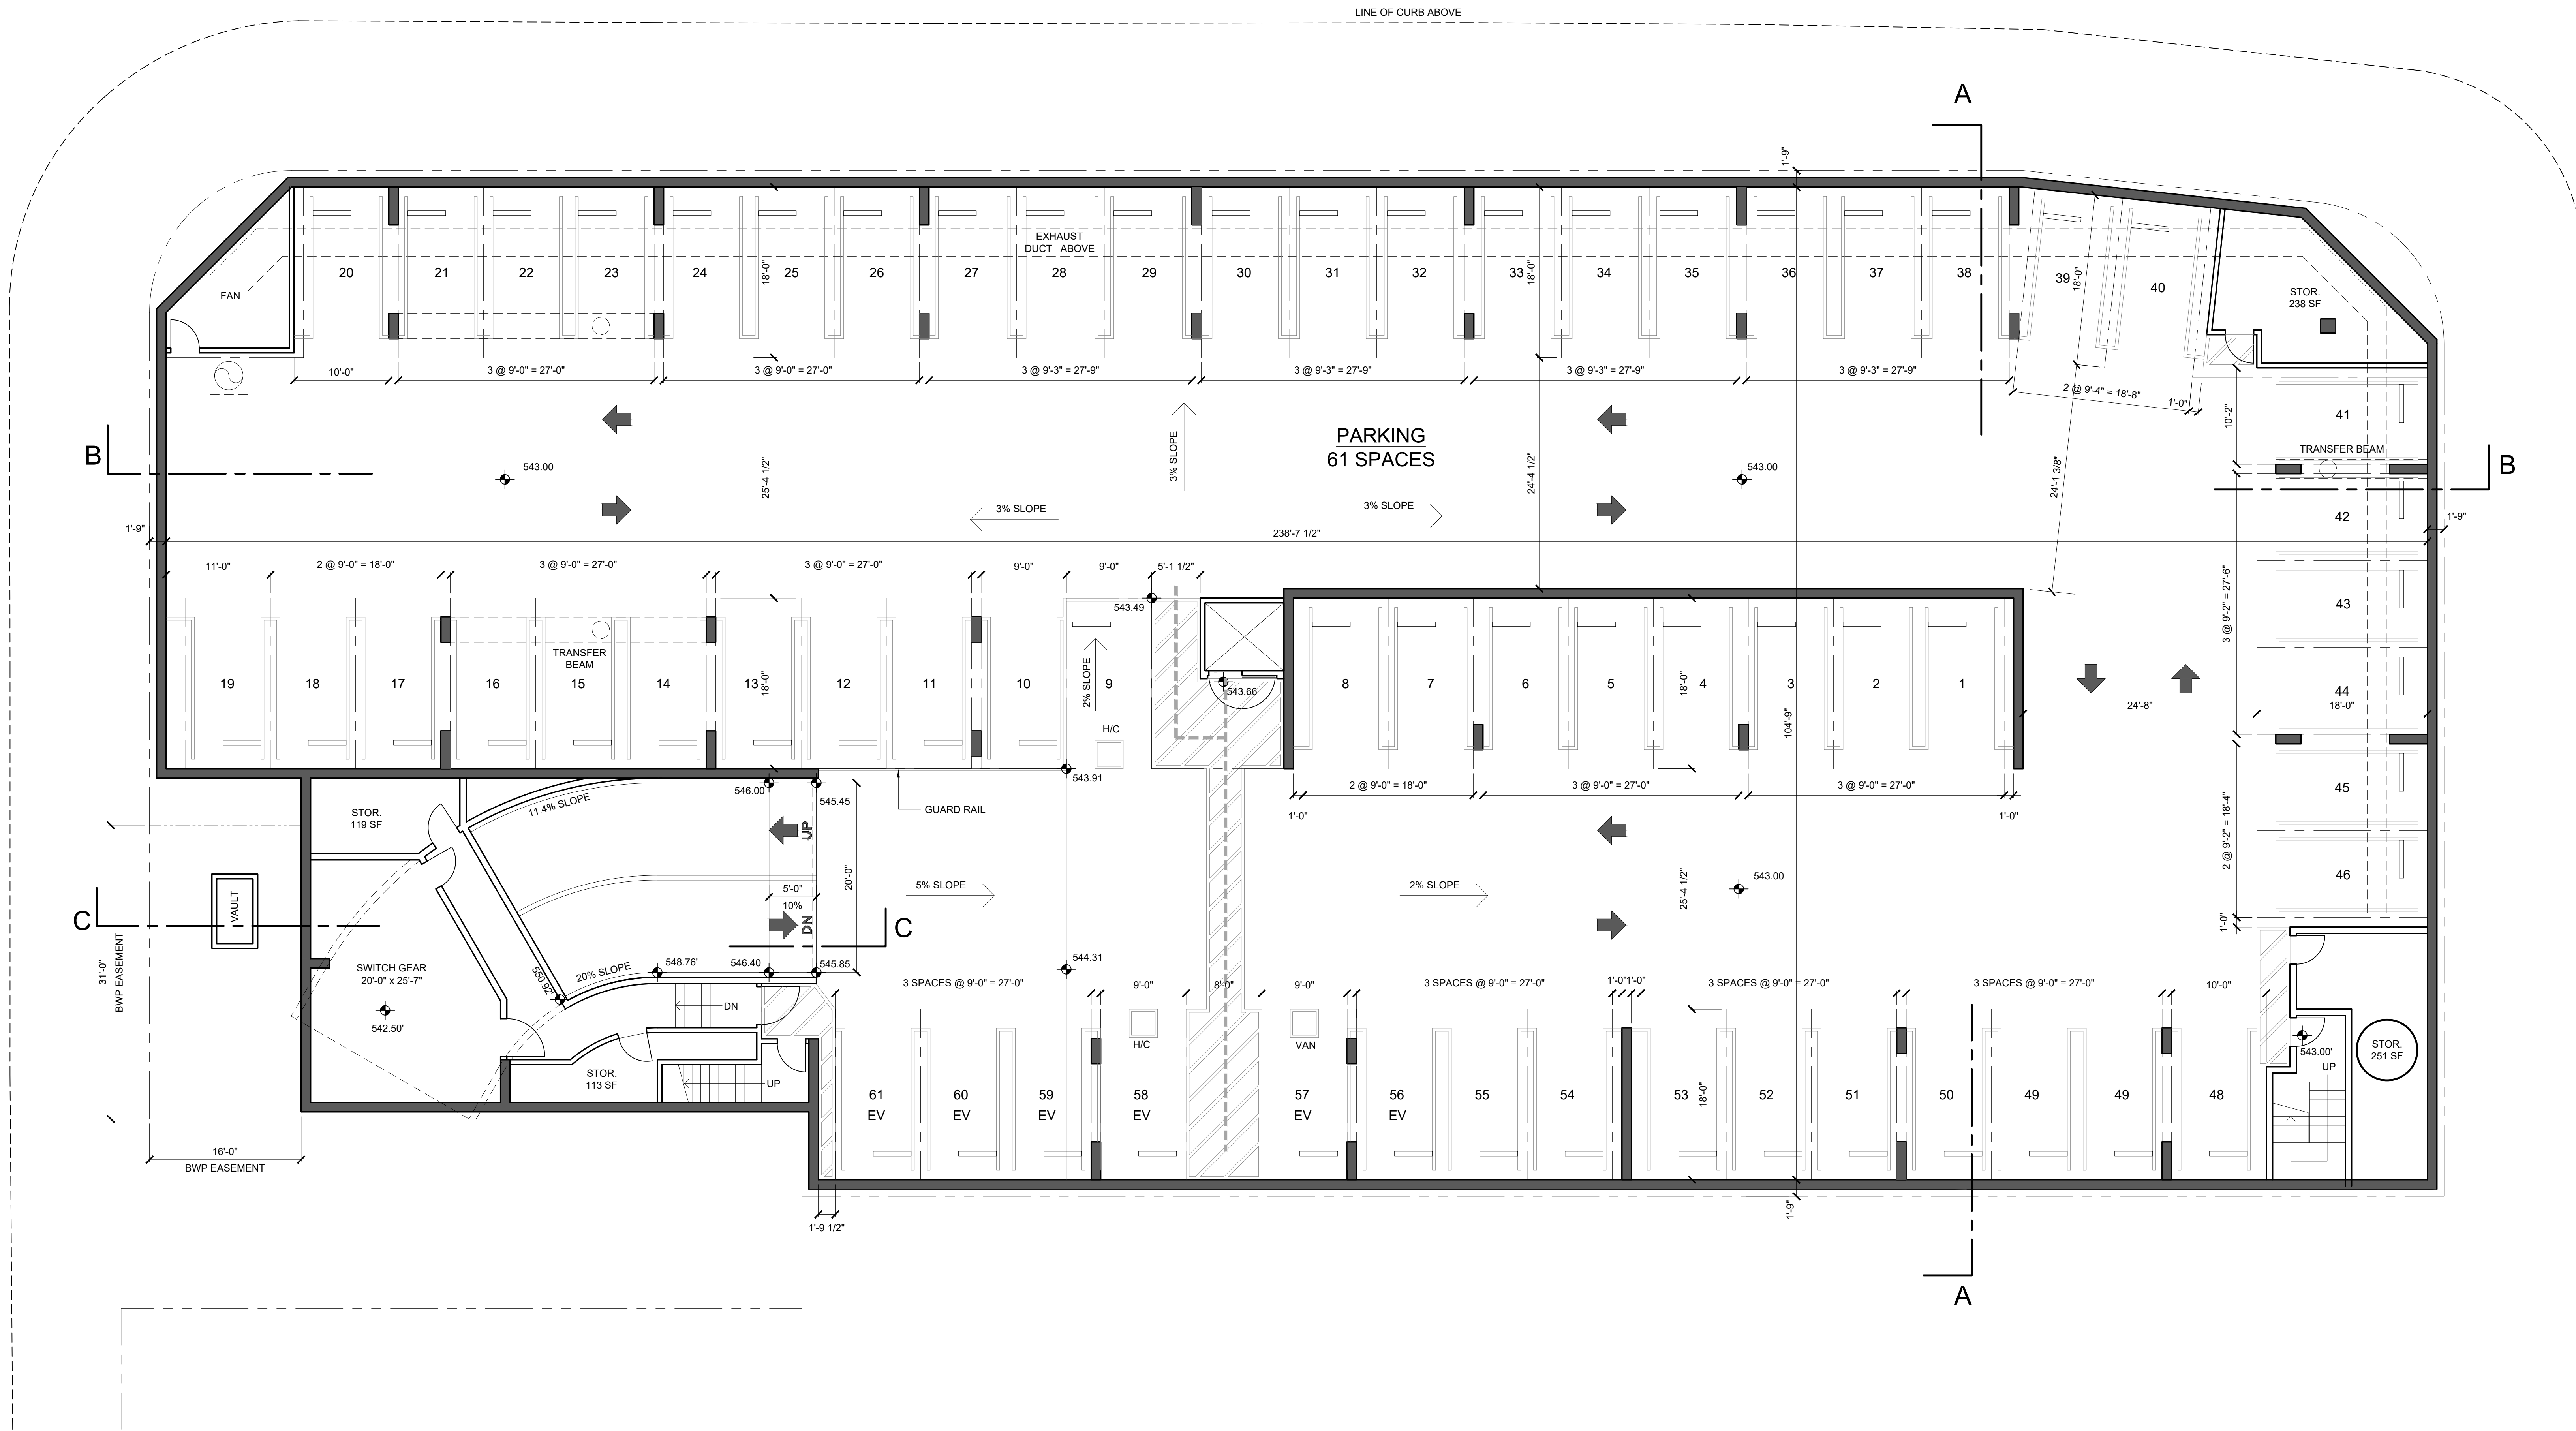










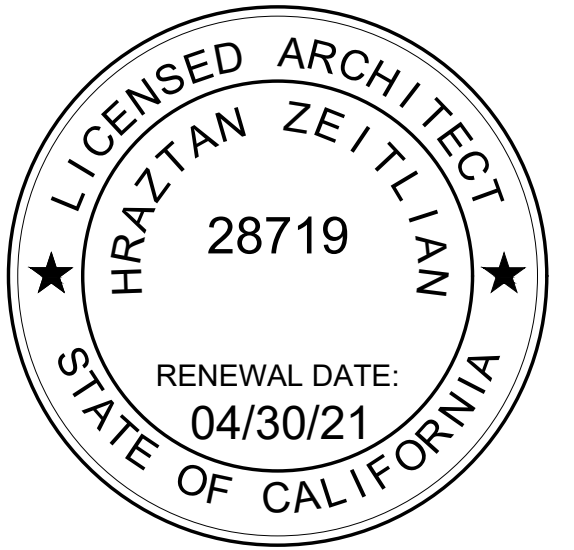

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CUP & DR SUBMITTAL	2/15/19
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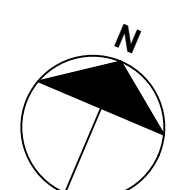
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**SIXTH FLOOR PLAN**


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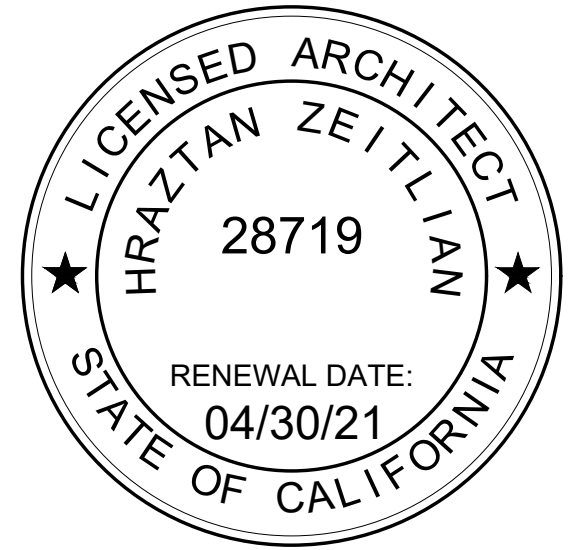
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**SIXTH FLOOR PLAN**







3700 W. RIVERSIDE  
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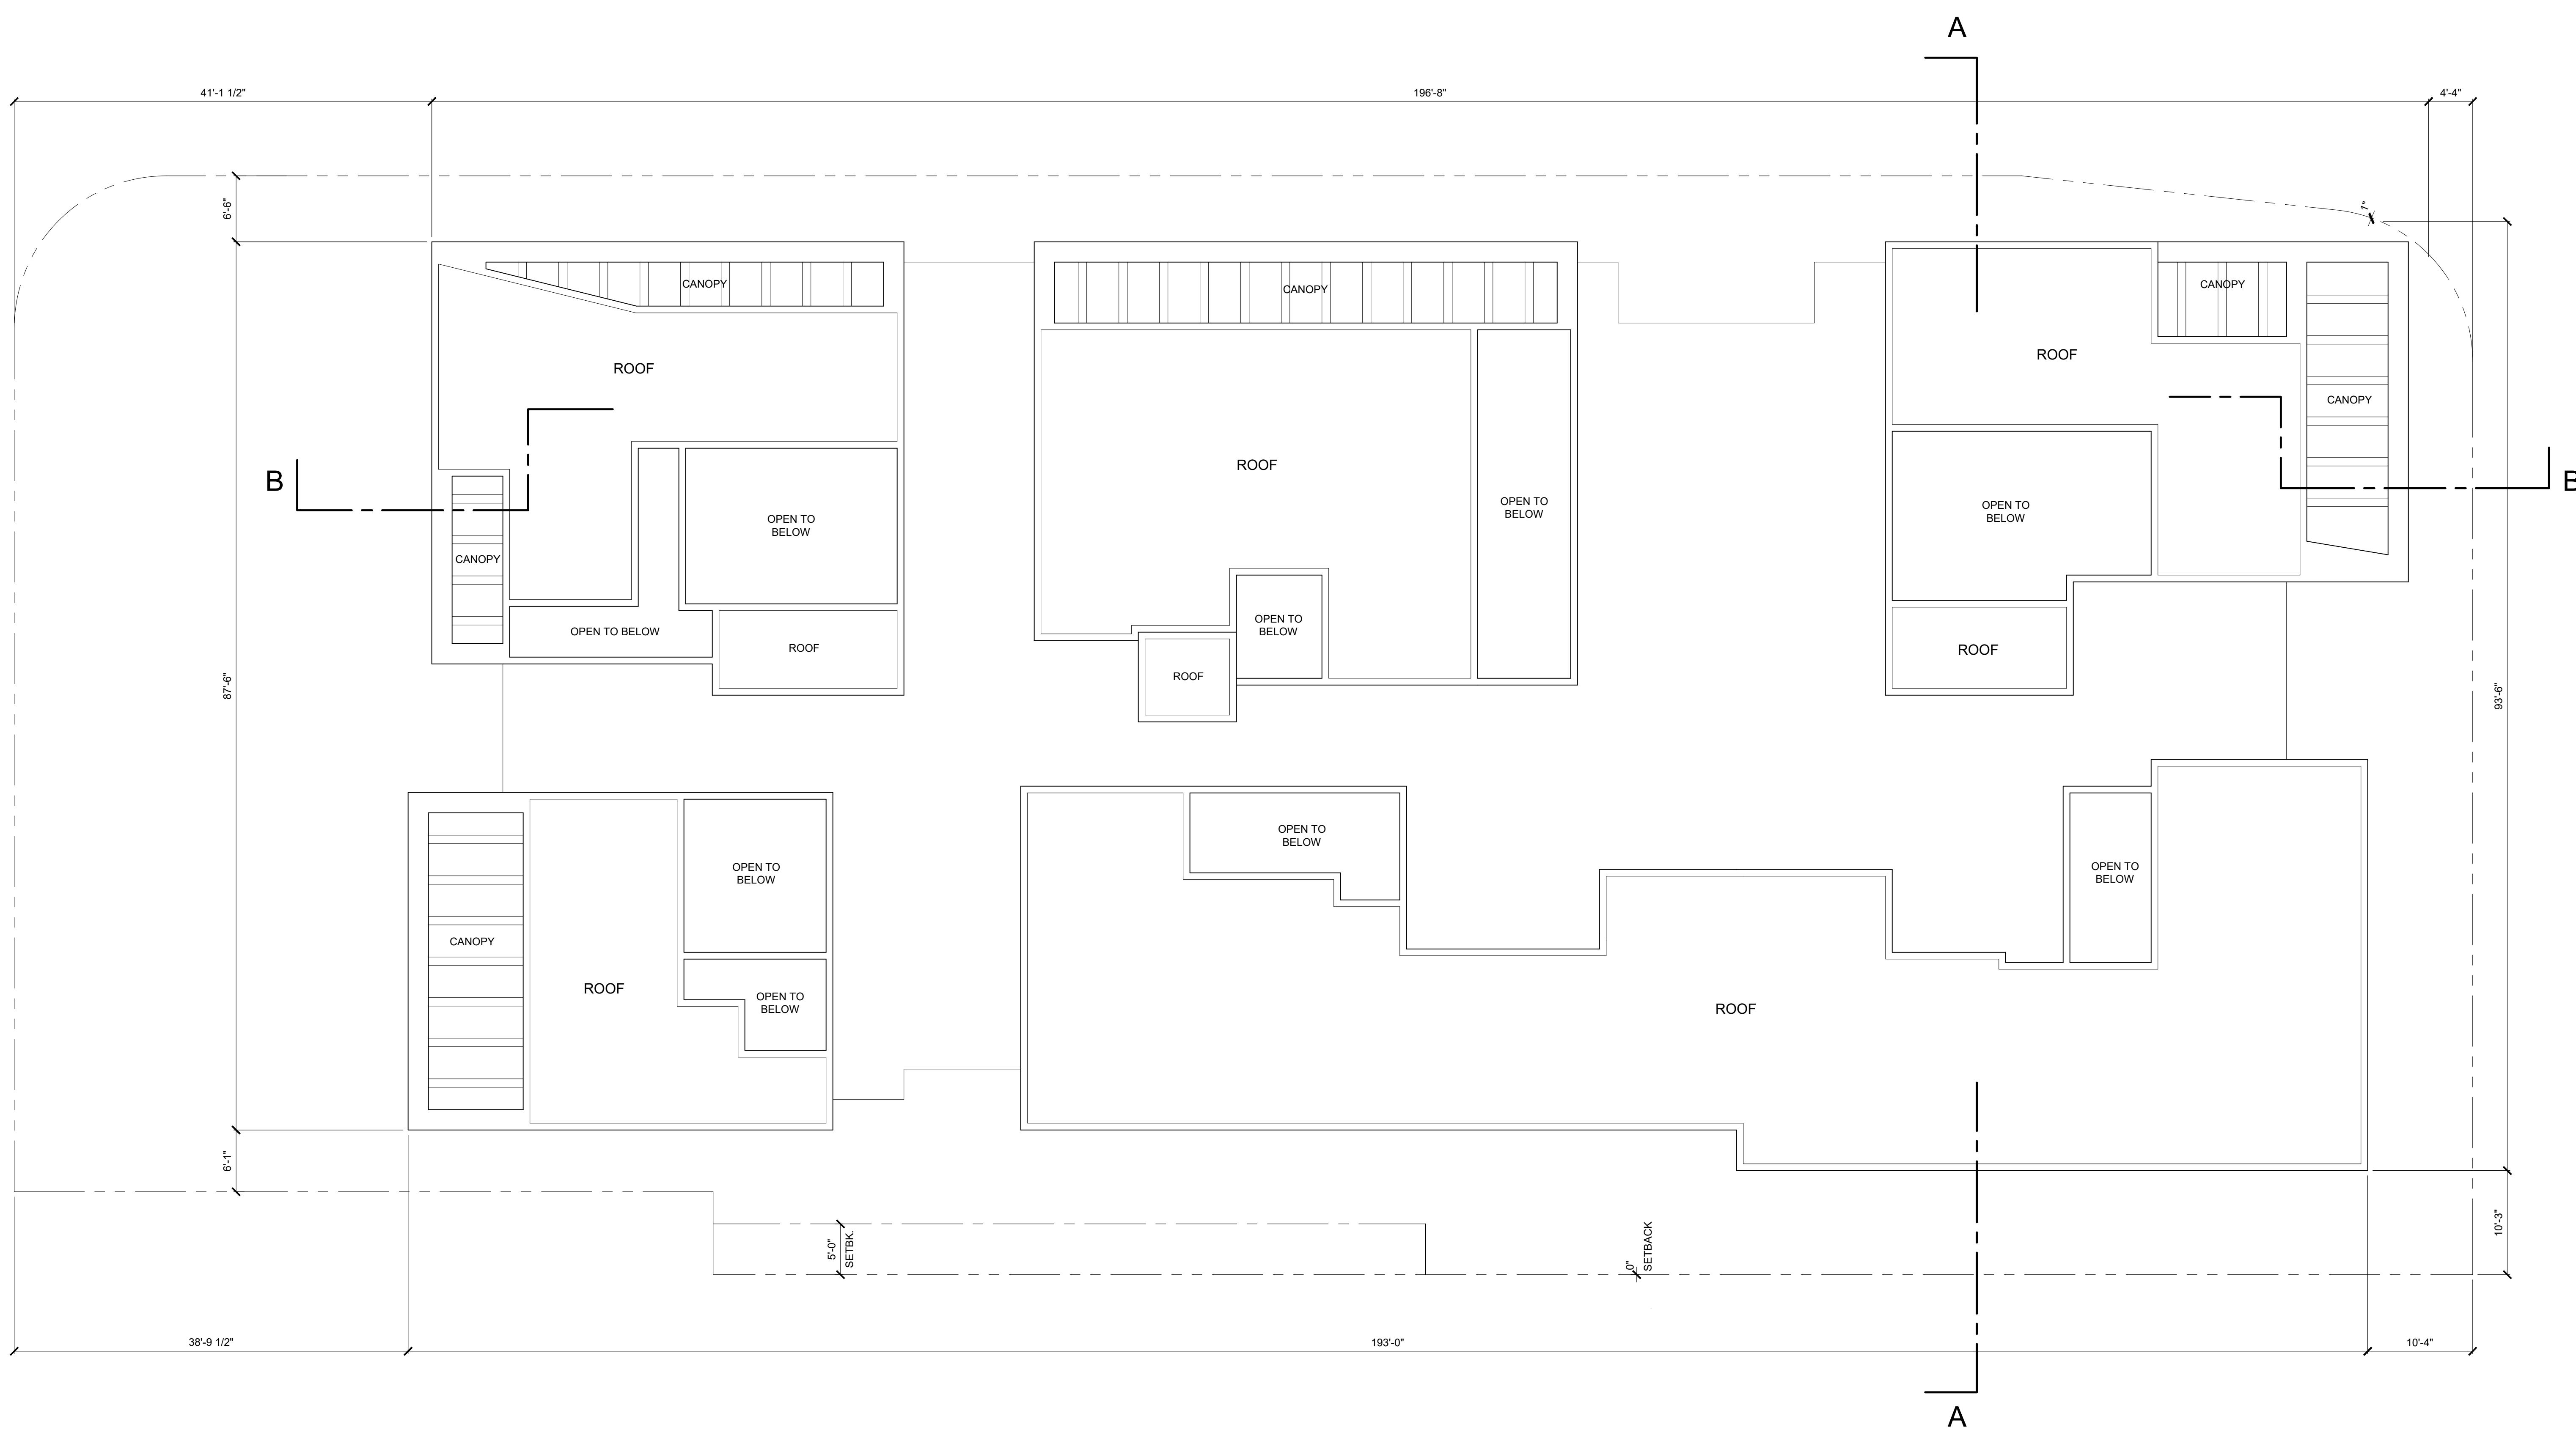
3700 RIVERSIDE  
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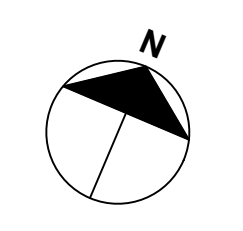
CUP & DR SUBMITTAL	2/15/19
CUP & DR RE-SUBMITTAL	9/30/19

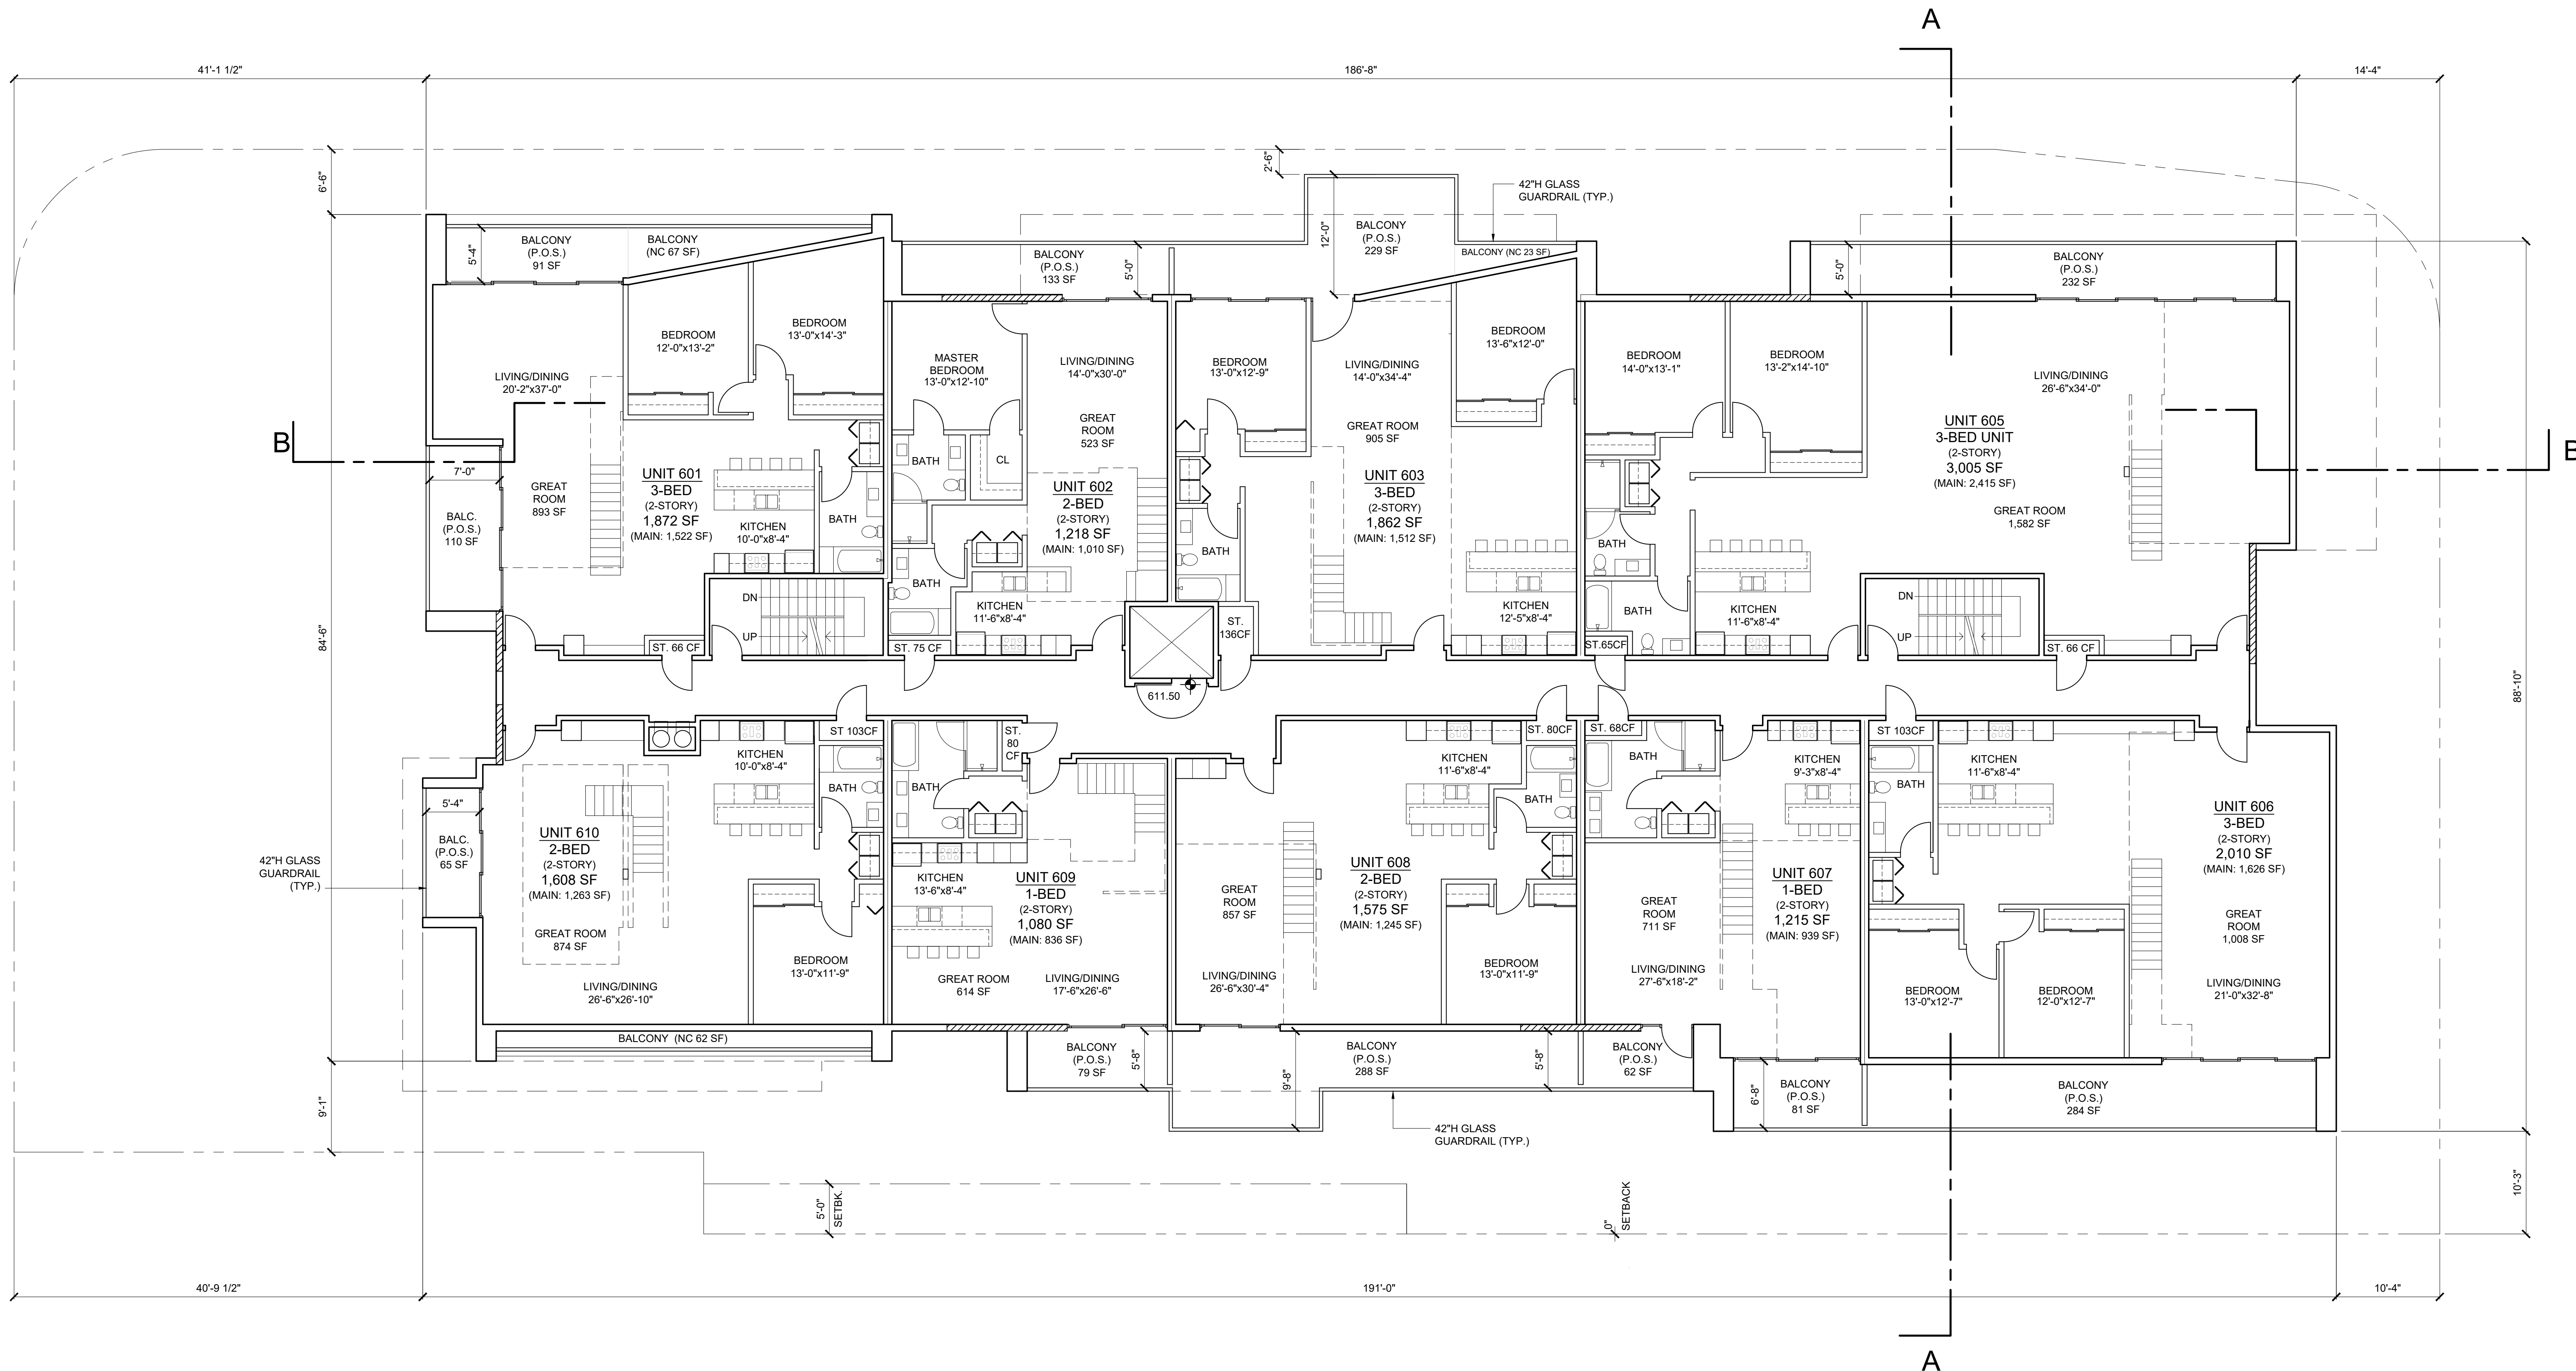ISSUE DESCRIPTION	DATE

SHEET TITLE  
**UPPER ROOF PLAN**  
SHEET NUMBER  
**A2.8**




UPPER ROOF PLAN



SCALE  
1/8" = 1'-0" 1



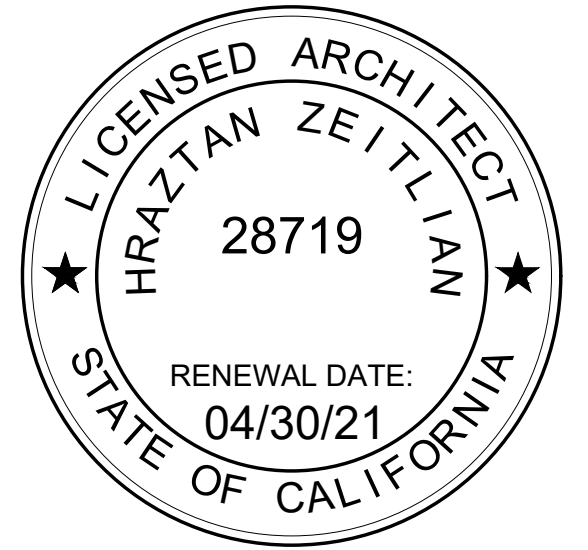

**WEST ELEVATION**

**EAST ELEVATION**

**EXTERIOR MATERIALS:**

**CONC-1**  
CAST IN PLACE BOARD FORMED CONCRETE. ARCHITECTURAL GRADE. FORMWORK TO IMPRINT 6" NOMINAL HORIZONTAL WOOD BANDS PATTERN ON CONCRETE VISIBLE SURFACES. FORMWORK INTERIOR TO BE SHAPED TO ALLOW FOR BLEEDING JOINTS BETWEEN 6" WOOD BANDS. FILL AND PATCH FORMWORK PANEL FASTENERS NOT TO BE NOTICEABLE. WHEN EXPOSED, POLISH TOP EXPOSED SURFACE OF WALLS.

**GL-1**  
INSULATED GLAZING UNIT. USE VITRO ARCHITECTURAL GLASS (FORMERLY PPG GLASS) 1/4" SOLARBAN 70XL SOLARBLUE SURFACE #2, 1/2" AIRSPACE, 1/4" CLEAR GLASS. SHGC VALUE .23. CONTACT: LOUIS PLASCENCIA 323.353.1563. LPLASCENCIA@OBE.COM.  
NOTE: ALL RESIDENTIAL LEVELS. GLASS REFLECTIVITY 8%.

**GL-2**  
INSULATED GLAZING UNIT. USE VITRO ARCHITECTURAL GLASS (FORMERLY PPG GLASS) SOLARBAN 70XL (2), FINISH: CLEAR + CLEAR GLASS. SHGC VALUE .27. CONTACT: LOUIS PLASCENCIA 323.353.1563. LPLASCENCIA@OBE.COM.  
NOTE: GROUND FLOOR GLASS. GLASS REFLECTIVITY DOES NOT EXCEED 15%.

**GL-3**  
TRANSLUCENT GLASS. USE VANCEVA ARCTIC SNOW COLOR CODE 0009. CONTACT: MICHAEL ONDRUS 419.705.8857.  
GLASS REFLECTIVITY DOES NOT EXCEED 15%.

**GL-4**  
GUARDRAILS CLEAR GLASS. USE C.R. LAURENCE GLASS GUARDRAIL ASSEMBLY. GLASS REFLECTIVITY DOES NOT EXCEED 15%.

**MT-1**  
PAINTED ALUMINUM MULLIONS. USE PPG DURANAR UC51595XL MEDIUM GRAY. CONTACT: 888.PPG.IDEA. WWW.PPGMETAL-COATINGS.COM

**MT-2**  
FORMED METAL PANEL. USE MITSUBISHI CHEMICAL COMPOSITES AMERICA, INC. ALPOLIC MICA MZG GREY 4MM. FASTENING TO PANEL FRAMEWORK TO BE ADHESIVES AND/OR HIGH BOND TAPES - NO RIVETS OR THREADED FASTENERS VISIBLE FROM EXTERIOR (INCLUDES ALL SITELINES AND JOINT CONDITIONS). CONTACT: ROBERT DUKER 757.404.7658. DUKER@ALPOLIC.COM.

**MT-3**  
PERFORATED METAL SCREEN PANEL ASSEMBLY ON EXPOSED TOP AND BOTTOM TRACKS. USE MOZ LASER CUT ALUMINUM MORPH PATTERN. FINISH: DARK GREY METALLIC POWDER. CONTACT: STEVE NAVIN 310.309.9390. STEVE@PREMIER-SALES.US.

**MT-4**  
CORRUGATED METAL CLADDING. MANUFACTURER TO BE: AEP SPAN. PRODUCT TO BE: REVERSED BOX RIB. FINISH TO BE DURA TECH 5000 COATING. COLOR TO BE: COOL MIDNIGHT BRONZE. AEP SPAN 800.733.4955 WWW.AEPSPAN.COM.

**PT-1**  
EXTERIOR BASE PAINT. USE SHERWIN-WILLIAMS SW 7669 SUMMIT GRAY.

**ST-1**  
EXTERIOR STUCCO CEMENT PLASTER. USE LA HABRA SBMF (SANTA BARBARA MISSION FINISH), STEEL TROWELED SMOOTH FINISH. EXTERIOR COLOR COAT STUCCO PLASTER. BASE COLOR TO BE BASE 200 X-16 SILVER GREY. STUCCO TO BE PAINTED PT-1. CONTACT: TED JONES 714.778.2266.

**WD-1**  
EXTERIOR WOOD CLADDING. USE PRODEMA PRODEX. FINISH: LIGHT BROWN. CONTACT: STEVE FOSTER 626.253.1814. STEVE@FOSTERAP.COM.

**EXTERIOR WINDOWS**

EXTERIOR WINDOWS TO BE FLOOR TO CEILING STOREFRONT. FINISH TO BE MT-1. FRAMES TO BE 2 1/2" WIDE. USE "US ALUMINUM" STOREFRONT OR EQUAL.

**EXTERIOR DOORS**

EXTERIOR DOORS TO BE GLAZED AND PART OF "US ALUMINUM" OR EQUAL STOREFRONT SYSTEM. FINISH OF METAL FRAMES TO BE MT-1. FRAMES TO BE 2 1/2" WIDE MINIMUM.

**EXTERIOR LIGHT FIXTURES**

FOR GROUND FLOOR LIGHTING SEE LIGHTING PLAN SHEET.

MARQUEE ON NORTH AND EAST FAÇADE AT GROUND FLOOR TO BE INTERNALLY ILLUMINATED WITH CONCEALED CONTINUOUS LED STRIPS BEHIND TRANSLUCENT GLAZING GL-3. LED LIGHTING STRIPS THEMSELVES WILL NOT BE VISIBLE.

ALL EXTERIOR VISIBLE LIGHTS ON FLOORS 2 to 7 TO BE RECESSED IN OVERHEAD SOFFITS. USE 4" DIAMETER RECESSED EXTERIOR LED DOWNLIGHTS. USE LITHONIA WF4, TRIM TO BE BRUSHED NICKLE.

**WEST & EAST ELEVATIONS**

SCALE  
1/8"=1'-0" 1

3700 W. RIVERSIDE INVESTMENTS, LLC  
127 N. MADISON AVE., SUITE 200  
PASADENA, CA 91101

3700 RIVERSIDE DRIVE  
MIXED-USE PROJECT


3700 W. RIVERSIDE DRIVE  
BURBANK, CA 91505

CUP & DR SUBMITTAL	2/15/19
CUP & DR RE-SUBMITTAL	9/30/19

ISSUE DESCRIPTION	DATE

SHEET TITLE  
**EAST & WEST ELEVATIONS**

SHEET NUMBER  
**A3.2**

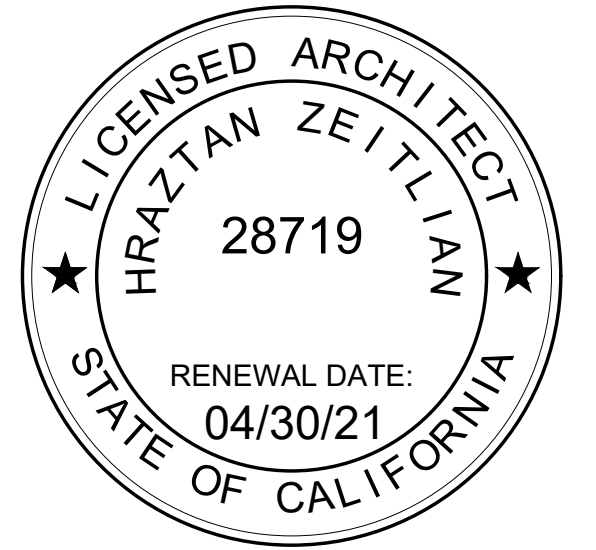

**EXTERIOR MATERIALS:**

**CONC-1**  
CAST IN PLACE BOARD FORMED CONCRETE. ARCHITECTURAL GRADE. FORMWORK TO IMPRINT 6" NOMINAL HORIZONTAL WOOD BANDS PATTERN ON CONCRETE VISIBLE SURFACES. FORMWORK INTERIOR TO BE SHAPED TO ALLOW FOR BLEEDING JOINTS BETWEEN 6" WOOD BANDS. FILL AND PATCH FORMWORK PANEL FASTENERS NOT TO BE NOTICEABLE. WHEN EXPOSED, POLISH TOP EXPOSED SURFACE OF WALLS.

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NOTE: ALL RESIDENTIAL LEVELS. GLASS REFLECTIVITY 8%.

**GL-2**  
INSULATED GLAZING UNIT. USE VITRO ARCHITECTURAL GLASS (FORMERLY PPG GLASS) SOLARBAN 70XL (2). FINISH: CLEAR + CLEAR GLASS. SHGC VALUE .27. CONTACT: LOUIS PLASCENCIA 323.353.1563. LPLASCENCIA@OBE.COM.  
NOTE: GROUND FLOOR GLASS. GLASS REFLECTIVITY DOES NOT EXCEED 15%.

**GL-3**  
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3700 W. RIVERSIDE INVESTMENTS, LLC  
127 N. MADISON AVE., SUITE 200  
PASADENA, CA 91101

3700 RIVERSIDE DRIVE  
MIXED-USE PROJECT

3700 W. RIVERSIDE DRIVE  
BURBANK, CA 91505

CUP & DR SUBMITTAL	2/15/19
CUP & DR RE-SUBMITTAL	9/30/19



ISSUE DESCRIPTION

SHEET TITLE

**SOUTH ELEVATION**

SHEET NUMBER

**A3.3**

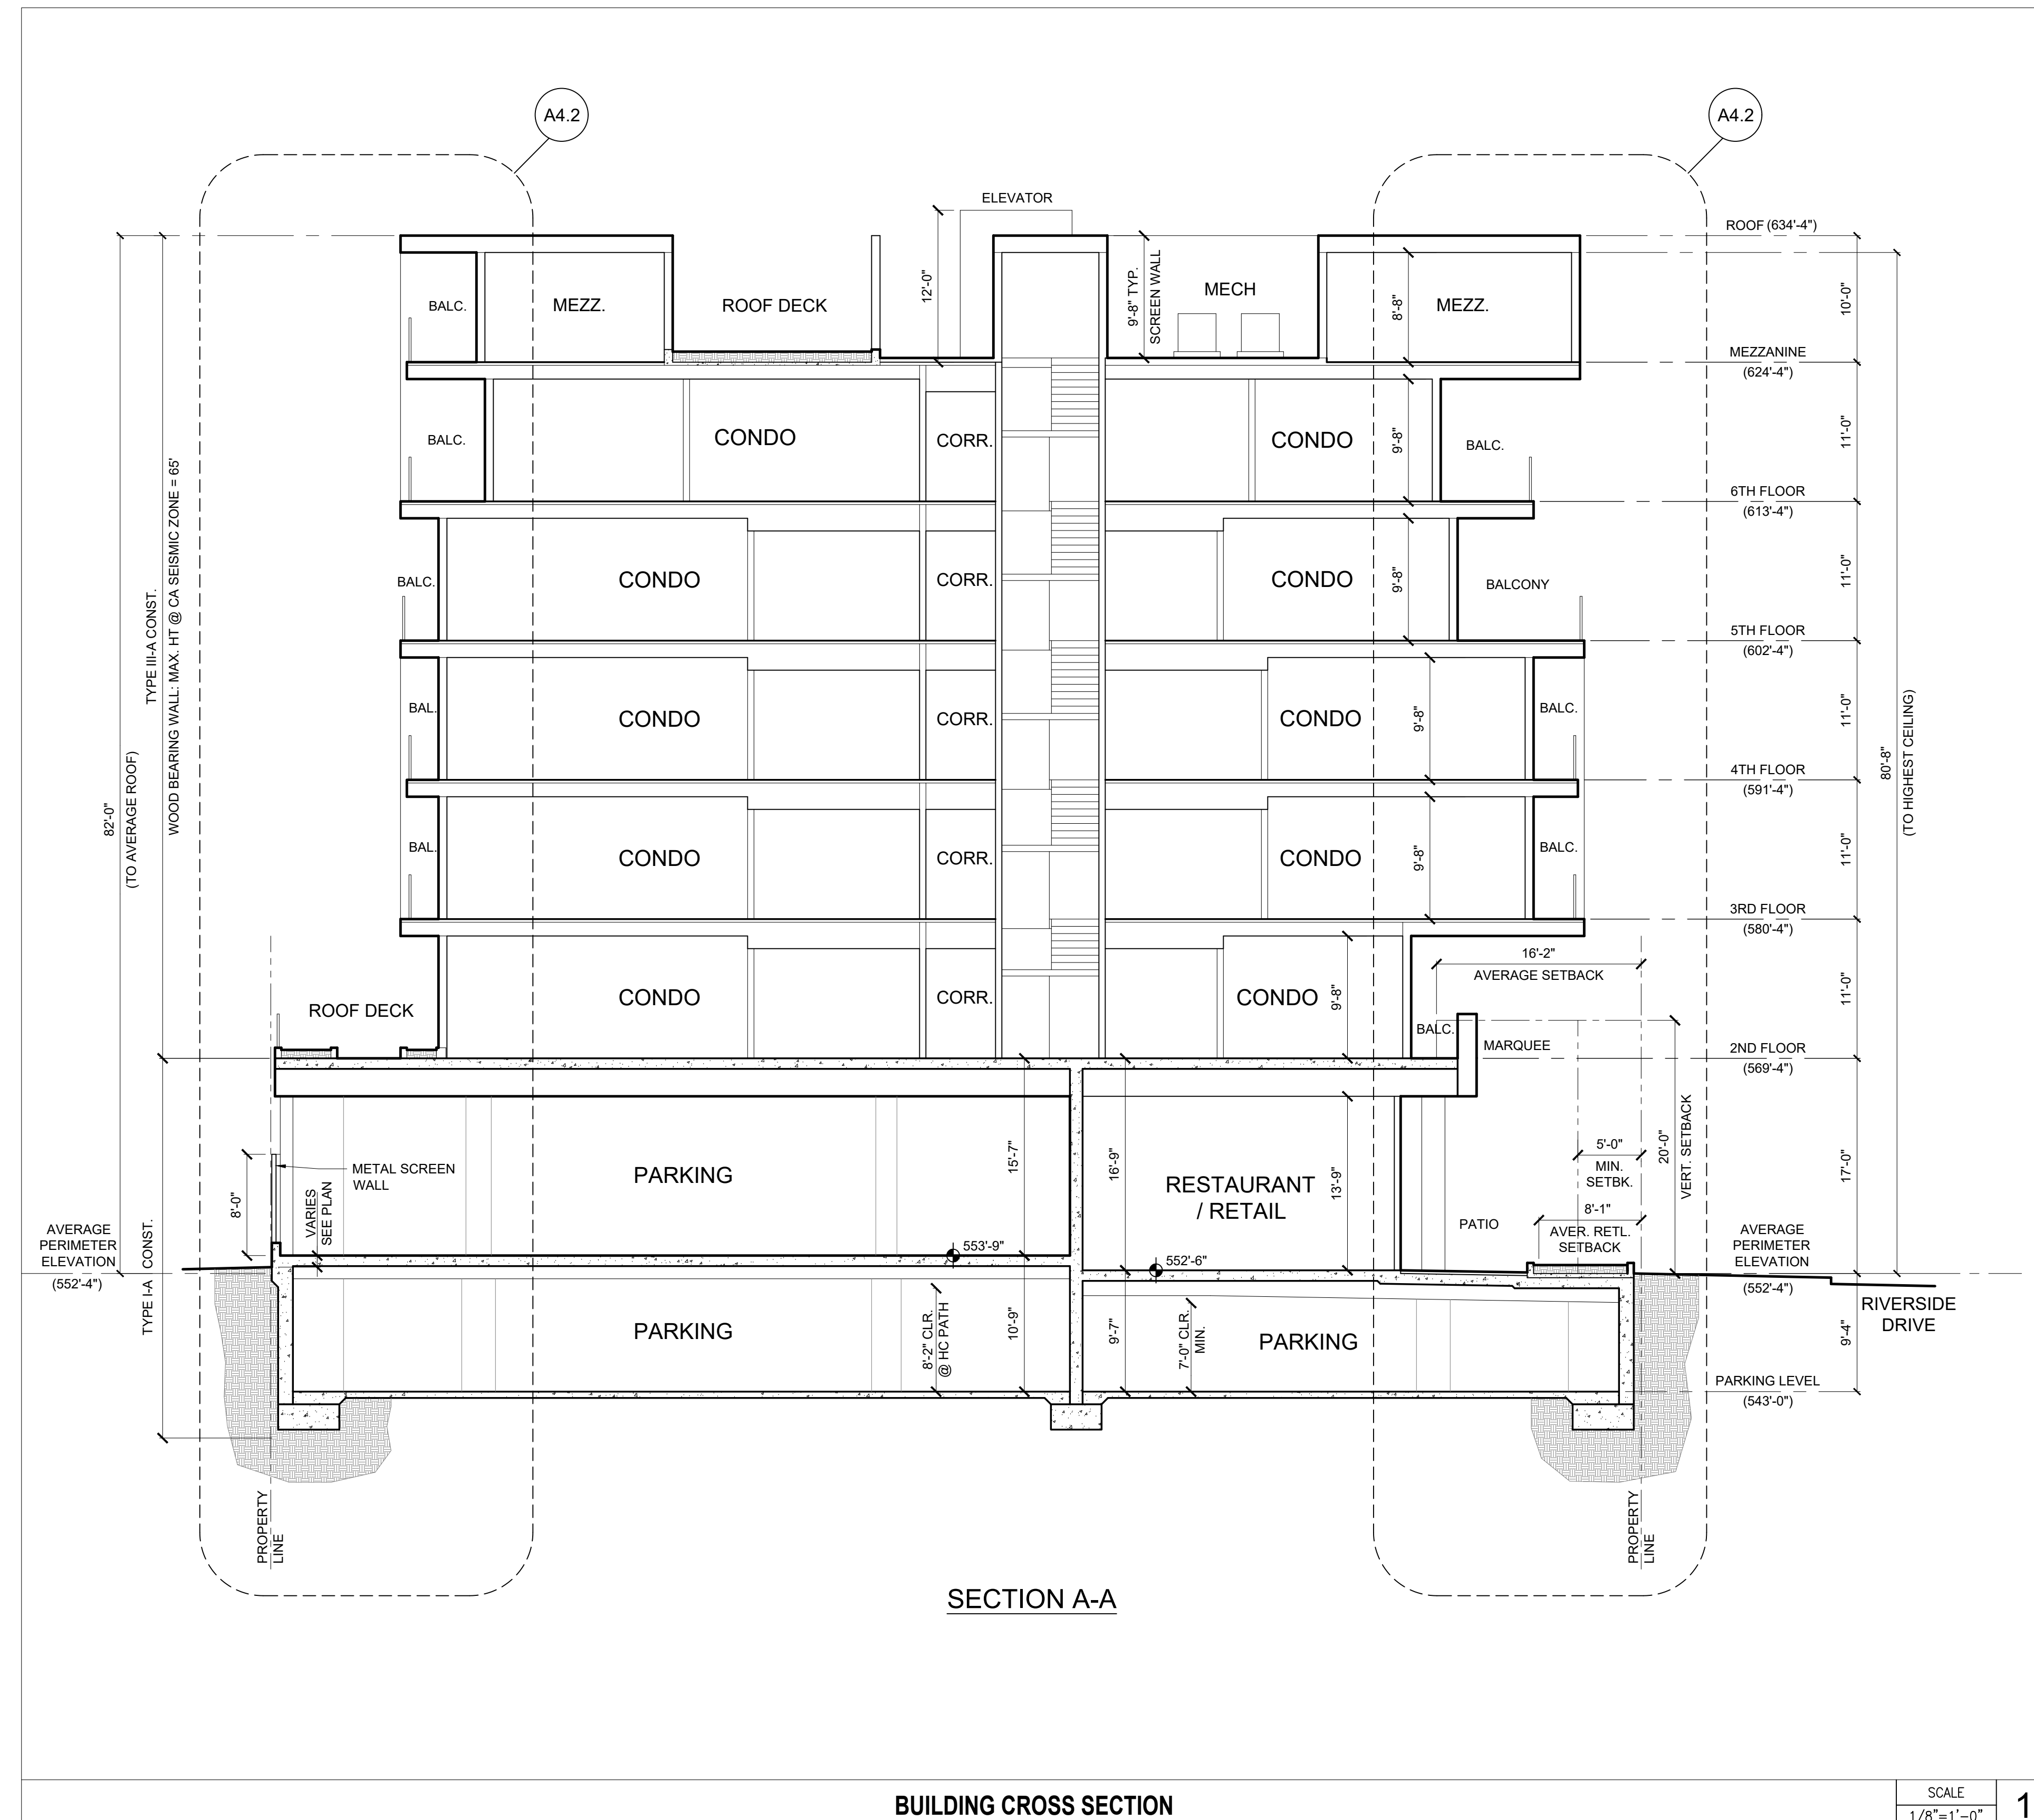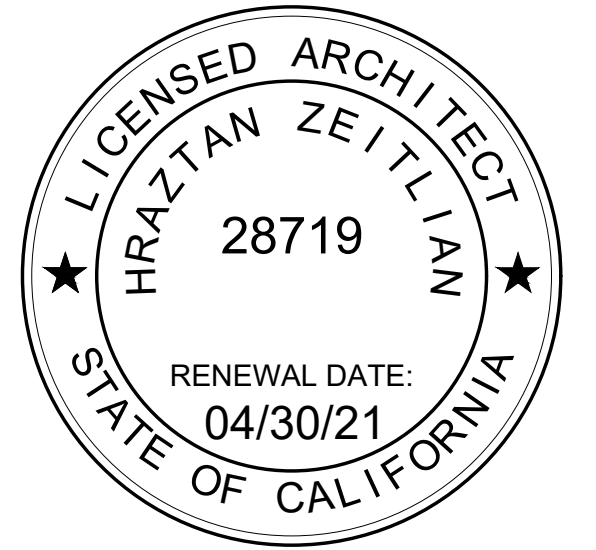

**BUILDING CROSS SECTION**

SCALE  
1/8"=1'-0"

1

3700 W. RIVERSIDE INVESTMENTS, LLC  
127 N. MADISON AVE., SUITE 200  
PASADENA, CA 91101

3700 RIVERSIDE DRIVE MIXED-USE PROJECT

3700 W. RIVERSIDE DRIVE BURBANK, CA 91505

CUP & DR SUBMITTAL	2/15/19
CUP & DR RE-SUBMITTAL	9/30/19

ISSUE DESCRIPTION

SHEET TITLE

**BUILDING CROSS SECTION**

SHEET NUMBER

**A4.1**









# CALIFORNIA SURVEYING SERVICE

R.J. Smith - L.S. 5189  
 Phone: (818) 957-3345  
 Email: randall2741@att.net  
 Job No. 2531

AS TO THE TITLE MATTERS HEREON, THE UNDERSIGNED HAS RELIED SOLELY UPON THE INFORMATION PROVIDED BY LAWYERS TITLE COMPANY IN THEIR PRELIMINARY REPORT DATED OCTOBER 17, 2017, FILE NO: 117040234. THE UNDERSIGNED MAKES NO STATEMENTS AS TO THE ACCURACY OR COMPLETENESS OF THE SUBJECT TITLE REPORT.



TO: 3700 W. RIVERSIDE INVESTMENTS, LLC., A CALIFORNIA LIMITED LIABILITY COMPANY, AND LAWYERS TITLE COMPANY AND ITS SUCCESSORS AND/OR ASSIGNS.

## SURVEYOR'S CERTIFICATE

THIS IS TO CERTIFY THAT THIS MAP OR PLAT AND THE SURVEY ON WHICH IT IS BASED WERE MADE ON OCTOBER 2, 2017 UNDER THE UNDERSIGNED'S SUPERVISION AND IN ACCORDANCE WITH MINIMUM STANDARD DETAIL REQUIREMENTS FOR ALTA/ACSM LAND TITLE SURVEYS, JOINTLY ESTABLISHED AND ADOPTED BY ALTA AND NSPS IN 2005, AND INCLUDES ITEMS 1, 2, 3, 4, 5, 6(a), 8, 9, 10(a), 11(a), AND 14 OF TABLE "A" THEREOF. PURSUANT TO THE ACCURACY STANDARDS AS ADOPTED BY ALTA AND NSPS AND IN EFFECT ON THE DATE OF THIS CERTIFICATION, UNDERSIGNED FURTHER CERTIFIES THAT, IN MY PROFESSIONAL OPINION AS A LAND SURVEYOR LICENSED IN THE STATE OF CALIFORNIA THE RELATIVE POSITIONAL ACCURACY OF THIS SURVEY DOES NOT EXCEED THAT WHICH IS SPECIFIED THEREIN.

DATE: 10/27/17, REVISED 02/12/18

*Randall J. Smith*  
 RANDALL J. SMITH, P.L.S. 5189

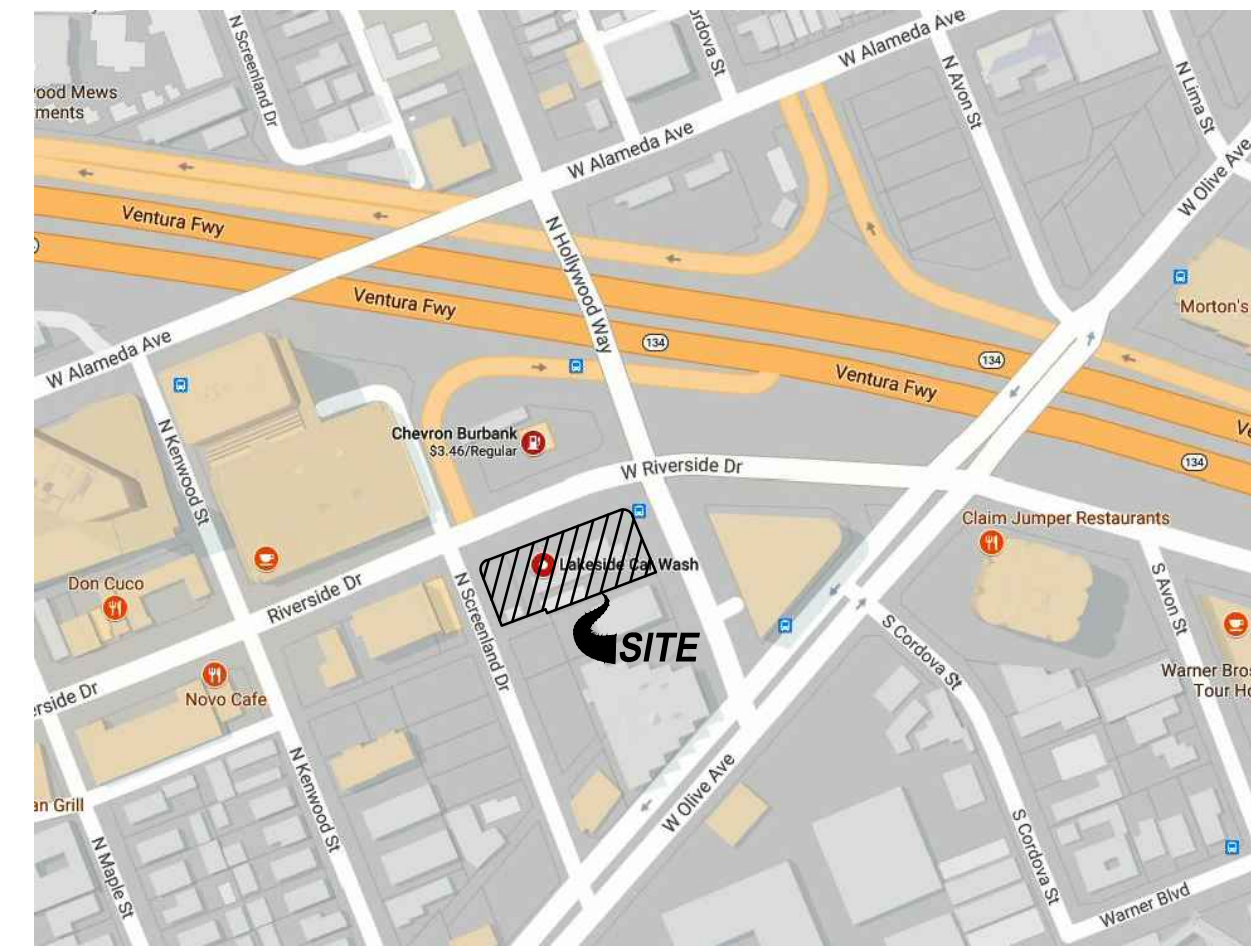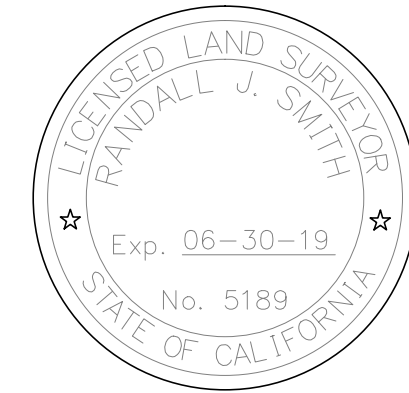

VICINITY MAP  
 NO SCALE

## BENCH MARK:

BM #1104-1 ELEVATION: 549.144 (FT)  
 2-1/2" BRASS CAP STMP CITY OF BURBANK BM 1104-1 AT THE NORTHWEST QUADRANT OF THE INTERSECTION OF OLIVE AVENUE AND MAPLE STREET ABOUT 81 FEET NORTH OF THE CENTERLINE OF OLIVE AVENUE AND ABOUT 22 FEET WEST OF THE CENTERLINE OF MAPLE STREET. SET TOP NORTHWEST CORNER OF A 10X3.5 FOOT CATCH BASIN WEST SIDE OF MAPLE STREET AND ABOUT 10.5 FEET SOUTH OF F.H. #139.

## LEGAL DESCRIPTION:

**PARCEL 1:**  
 THAT PORTION OF LOT 1 BLOCK 62 OF RANCHO PROVIDENCIA AND SCOTT TRACT, IN THE CITY OF BURBANK, COUNTY OF LOS ANGELES, STATE OF CALIFORNIA, AS PER MAP RECORDED IN BOOK 43 PAGE 37, MISCELLANEOUS RECORDS, IN THE OFFICE OF THE COUNTY RECORDER OF SAID COUNTY, DESCRIBED AS FOLLOWS:

BEGINNING AT A POINT IN THE SOUTHERLY BOUNDARY OF RIVERSIDE DRIVE, SAID POINT BEING THE MOST NORTHERLY CORNER OF LOT 24, TRACT NO. 9440, AS PER MAP RECORDED IN BOOK 134 PAGES 53 AND 54 OF MISCELLANEOUS RECORDS OF LOS ANGELES COUNTY; THENCE ALONG SAID SOUTHERLY LINE NORTH 67°00'20" EAST 50.71 FEET; THENCE SOUTH 22°59'40" EAST 108.16 FEET; THENCE SOUTH 67°00'45" WEST 70.16 FEET TO A POINT IN THE EASTERLY LINE OF THE ABOVE MENTIONED LOT 24; THENCE ALONG SAID EASTERLY LINE NORTH 22°59'40" WEST 82.25 FEET, TO AN ANGLE POINT IN SAID EASTERLY LINE; THENCE NORTH 67°00'20" EAST 19.45 FEET ALONG THE BOUNDARY OF SAID LOT 24; THENCE NORTH 22°59'40" WEST 25.90 FEET ALONG THE BOUNDARY OF SAID LOT 24 TO THE POINT OF BEGINNING.

**PARCEL 2:**  
 A. THAT PORTION OF LOT 1 IN BLOCK 62 OF RANCHO PROVIDENCIA AND SCOTT TRACT, IN THE CITY OF BURBANK, COUNTY OF LOS ANGELES, STATE OF CALIFORNIA, AS PER MAP RECORDED IN BOOK 43 PAGE 37 ET SEQ., OF MISCELLANEOUS RECORDS, IN THE OFFICE OF THE COUNTY RECORDER OF SAID COUNTY, DESCRIBED AS FOLLOWS:

BEGINNING AT A POINT IN THE SOUTHERLY LINE OF RIVERSIDE DRIVE, DISTANT 50.71 FEET NORTHEASTERLY FROM THE MOST NORTHERLY CORNER OF LOT 24 OF TRACT NO. 9440, AS PER MAP RECORDED IN BOOK 134 PAGES 53 AND 54 OF MAPS, IN THE OFFICE OF THE COUNTY RECORDER OF SAID COUNTY; THENCE ALONG SAID SOUTHERLY LINE NORTH 67°00'20" EAST 108 FEET TO THE SOUTHWESTERLY LINE OF HOLLYWOOD WAY, 100 FEET WIDE; THENCE ALONG SAID SOUTHWEST LINE, SOUTH 22°50'40" EAST 58.17 FEET TO A LINE PARALLEL WITH THE SOUTHEAST LINE OF SAID LOT 1 AND DISTANT NORTHWESTERLY 125 FEET, MEASURED AT RIGHT ANGLES THEREFROM; THENCE ALONG SAID PARALLEL LINE, SOUTH 67°00'45" WEST 108 FEET; THENCE NORTH 22°59'40" WEST 58.16 FEET TO THE POINT OF BEGINNING.

B. ALL OF THE NORTH ONE-HALF OF THE NORTHWEST 50 FEET OF THE SOUTHEAST 125 FEET OF THE NORTHWEST 208.16 FEET OF LOT 1, BLOCK 62 OF RANCHO PROVIDENCIA AND SCOTT TRACT, IN THE CITY OF BURBANK, COUNTY OF LOS ANGELES, STATE OF CALIFORNIA, AS PER MAP RECORDED IN BOOK 43 PAGE 47 OF MISCELLANEOUS RECORDS, IN THE OFFICE OF THE COUNTY RECORDER OF SAID COUNTY.


EXCEPT THE NORTHEAST 30 FEET THEREOF IN THE STREET. ALSO EXCEPT THE WEST 70.16 FEET THEREOF.

C. THE SOUTH HALF OF THE NORTHWEST 50 FEET OF THE SOUTHEAST 125 FEET OF THE NORTHWEST 208.16 FEET OF LOT 1 IN BLOCK 62 OF RANCHO PROVIDENCIA AND SCOTT TRACT, IN THE CITY OF BURBANK, COUNTY OF LOS ANGELES, STATE OF CALIFORNIA, AS PER MAP RECORDED IN BOOK 43 PAGE 47 OF MISCELLANEOUS RECORDS, IN THE OFFICE OF THE COUNTY RECORDER OF SAID COUNTY.

EXCEPT THE NORTHEAST 30 FEET THEREOF IN THE STREET. ALSO EXCEPT THE SOUTHWEST 70.16 FEET THEREOF.

**PARCEL 3:**  
 LOT 24 OF TRACT NO. 9440, IN THE CITY OF BURBANK, COUNTY OF LOS ANGELES, STATE OF CALIFORNIA, AS PER MAP RECORDED IN BOOK 134 PAGES 53 AND 54, OF MAPS, IN THE OFFICE OF THE COUNTY RECORDER OF SAID COUNTY; A PORTION OF SAID LAND IS INCLUDED WITHIN THE NORTHEASTERLY 208.16 FEET OF THE SOUTHWESTERLY 157.97 FEET OF LOT 1 IN BLOCK 62 OF THE RANCHO PROVIDENCIA AND SCOTT TRACT, AS PER MAP RECORDED IN BOOK 43 PAGE 47 ET SEQ., OF MISCELLANEOUS RECORDS, IN THE OFFICE OF THE COUNTY RECORDER OF SAID COUNTY.

**PARCEL 4:**  
 LOT 25 OF TRACT NO. 9440, IN THE CITY OF BURBANK, COUNTY OF LOS ANGELES, STATE OF CALIFORNIA, AS PER MAP RECORDED IN BOOK 134 PAGES 53 AND 54, OF MAPS, IN THE OFFICE OF THE COUNTY RECORDER OF SAID COUNTY.

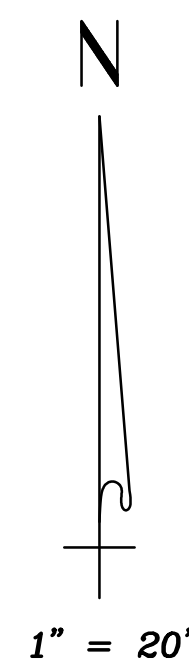

## BASIS OF BEARINGS:

THE BEARING OF N 67°00'20" E OF THE CENTERLINE OF RIVERSIDE DRIVE AS SHOWN ON RECORD OF SURVEY FILED IN BOOK 183, PAGE 20 OF RECORDS OF SURVEY, WAS TAKEN AS THE BASIS OF BEARINGS SHOWN ON THIS MAP.

## GENERAL NOTES:

ZONING: MDC-3 MEDIA DISTANT GENERAL BUSINESS  
 PROPERTY IN FLOOD ZONE "X", FIRM PANEL NO. 06037C1339F  
 DATED: 09-26-2008  
 A.P.N. 2485-005-014, 014, 015  
 AREA: 26,393 SQ.FT., 0.61 ACRES

C/A INT. EST. REC. ANGLE & DIST. FROM FD. MON'S ON S.E.L.Y. SIDE OF ALLEY PER R.S. 183-20

KENWOOD STREET

SCREENLAND DRIVE

RIVERSIDE DRIVE

HOLLYWOOD WAY

OLIVE AVENUE

ALLEY

LOT 25  
 PARCEL 4  
 APN: 2485-005-015

LOT 24  
 PARCEL 3  
 APN: 2485-005-014

LOT 23  
 PARCEL 2  
 APN: 2485-005-013

LOT 22  
 PARCEL 1  
 APN: 2485-005-012

LOT 21  
 PARCEL 1  
 APN: 2485-005-011

LOT 20  
 PARCEL 1  
 APN: 2485-005-010

LOT 19  
 PARCEL 1  
 APN: 2485-005-009

LOT 18  
 PARCEL 1  
 APN: 2485-005-008

LOT 17  
 PARCEL 1  
 APN: 2485-005-007

LOT 16  
 PARCEL 1  
 APN: 2485-005-006

LOT 15  
 PARCEL 1  
 APN: 2485-005-005

LOT 14  
 PARCEL 1  
 APN: 2485-005-004

LOT 13  
 PARCEL 1  
 APN: 2485-005-003

LOT 12  
 PARCEL 1  
 APN: 2485-005-002

LOT 11  
 PARCEL 1  
 APN: 2485-005-001

LOT 10  
 PARCEL 1  
 APN: 2485-005-000

LOT 9  
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 APN: 2485-005-000

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 APN: 2485-005-000

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LOT -51  
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LOT -53  
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LOT -54  
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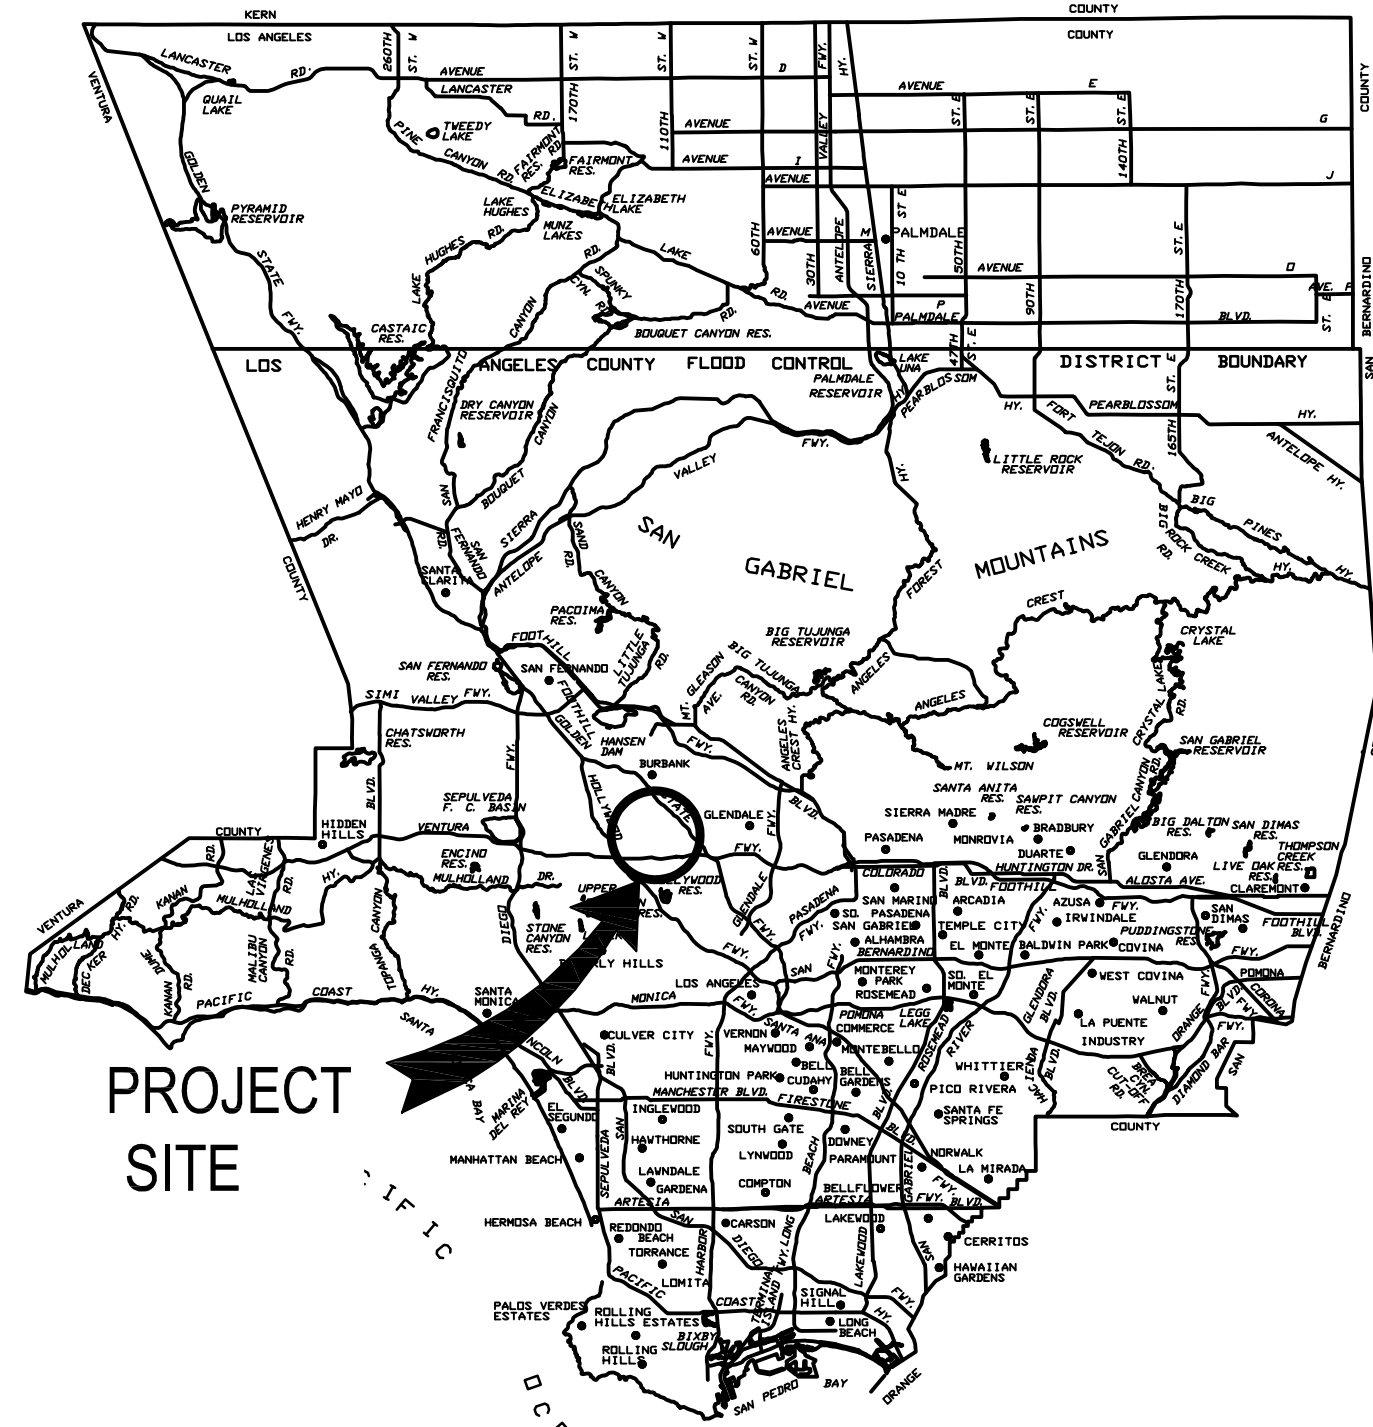
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LOT -97



LOCATION MAP  
NOT TO SCALE

# BURBANK, CALIFORNIA MIXED-USE DEVELOPMENT CONCEPTUAL GRADING PLAN

## LEGAL DESCRIPTION:


THE LAND REFERRED TO IN THIS COMMITMENT IS SITUATED IN THE CITY OF LOS ANGELES, COUNTY OF LOS ANGELES, STATE OF CALIFORNIA, AND IS DESCRIBED AS FOLLOWS:

LOT 1 OF BLOCK 62, RANCHO PROVIDENCIA AND SCOTT TRACT, IN THE CITY OF BURBANK, COUNTY OF LOS ANGELES, STATE OF CALIFORNIA, AS PER MAP RECORDED IN MAP BOOK 43 PG 37, MISCELLANEOUS RECORDS, IN THE OFFICE OF THE COUNTY RECORDER OF SAID COUNTY.

LOT 24 AND 25 OF TRACT NO. 9440, IN THE CITY OF BURBANK, COUNTY OF LOS ANGELES, STATE OF CALIFORNIA, AS PER MAP RECORDED IN MAP BOOK 134 PGS 53 AND 54, MISCELLANEOUS RECORDS, IN THE OFFICE OF THE COUNTY RECORDER OF SAID COUNTY.

LOCATION: 3700 WEST RIVERSIDE DRIVE, BURBANK, CA 91505

APN(S): 2485-005-004, 014, 015

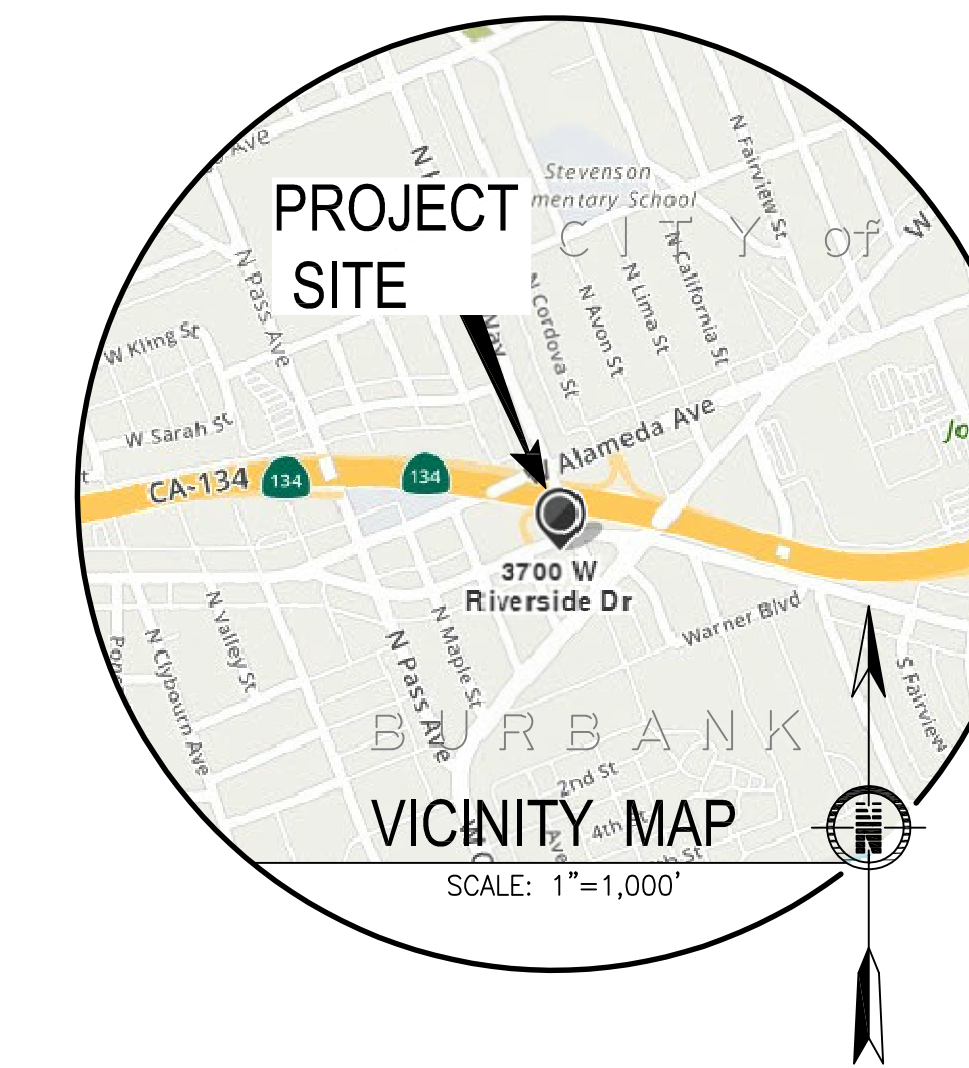

VICINITY MAP  
SCALE: 1"=1,000'

## GENERAL NOTES:

- ALL GRADING AND CONSTRUCTION SHALL CONFORM TO THE BUILDING CODES ADOPTED BY CITY OF BURBANK IN 2016, BURBANK MUNICIPAL CODE (TITLE 9, CHAPTER 1) AND THE STATE MODEL WATER EFFICIENCY LANDSCAPE ORDINANCE UNLESS SPECIFICALLY NOTED ON THESE PLANS.
- ALL WORK INDICATED HEREON SHALL BE DONE IN ACCORDANCE WITH THE PROJECT SPECIFICATIONS.
- ALL DRAWINGS ARE CONSIDERED TO BE A PART OF THE CONTRACT DOCUMENTS. THE CONTRACTOR SHALL BE RESPONSIBLE FOR THE REVIEW AND COORDINATION OF ALL DRAWINGS AND SPECIFICATIONS PRIOR TO THE START OF CONSTRUCTION. ANY DISCREPANCIES THAT OCCUR SHALL BE BROUGHT TO THE ATTENTION OF THE ARCHITECT/ENGINEER PRIOR TO START OF CONSTRUCTION SO THAT A CLARIFICATION CAN BE ISSUED. ANY WORK PERFORMED IN CONFLICT WITH THE CONTRACT DOCUMENTS OR ANY CODE REQUIREMENTS SHALL BE CORRECTED BY THE CONTRACTOR AT THEIR OWN EXPENSE AND AT NO EXPENSE TO THE OWNER OR ARCHITECT/ENGINEER.
- THE ENGINEER PREPARING THESE PLANS WILL NOT BE RESPONSIBLE FOR, OR LIABLE FOR, UNAUTHORIZED CHANGES TO OR USES OF THESE PLANS. ALL CHANGES TO THE PLANS MUST BE IN WRITING AND MUST BE APPROVED BY THE PREPARER OF THESE PLANS.
- NOTES AND DETAILS ON DRAWINGS SHALL TAKE PRECEDENCE OVER GENERAL NOTES AND TYPICAL DETAILS, WHERE NO DETAILS ARE GIVEN, CONSTRUCTION SHALL BE AS SHOWN FOR SIMILAR WORK.
- ANY MODIFICATIONS OR CHANGES TO THESE PLANS MUST BE APPROVED BY THE BUILDING OFFICIAL.
- PRIOR TO COMMENCING CONSTRUCTION CONTRACTOR SHALL VERIFY THE JOIN CONDITIONS FOR GRADING, DRAINAGE AND UNDERGROUND FACILITIES, INCLUDING THE LOCATION AND ELEVATION OF ALL SURFACE JOIN CONDITIONS, AND INCLUDING LOCATION AND ELEVATION OF EXISTING UNDERGROUND FACILITIES AT CROSSINGS WITH PROPOSED UNDERGROUND FACILITIES IF CONDITIONS DIFFER FROM THOSE SHOWN ON THE PLANS, THE CONTRACTOR SHALL NOTIFY THE ENGINEER AND SHALL NOT BEGIN CONSTRUCTION UNTIL THE CHANGED CONDITIONS HAVE BEEN EVALUATED.
- ALL GRADING AND CONSTRUCTION ACTIVITIES SHALL COMPLY WITH BURBANK CODE, TITLE 9, SECTION 9-1-1-105.8 THAT CONTROLS AND RESTRICTS NOISE FROM THE USE OF CONSTRUCTION AND GRADING EQUIPMENT FROM THE HOURS OF 7:00 PM TO 7:00 AM, AND ON SUNDAYS AND HOLIDAYS.
- ALL DEBRIS AND FOREIGN MATERIAL SHALL BE REMOVED FROM THE SITE AND DISPOSED OF AT DISPOSAL SITES APPROVED BY THE BUILDING OFFICIAL OR AT A LEGAL DUMPSITE. THE CONTRACTOR SHALL OBTAIN NECESSARY PERMITS FOR THE TRANSPORTATION OF MATERIAL TO AND FROM THE SITE. RECEIPTS FOR ACCEPTANCE OF EXCESS MATERIAL BY A DUMPSITE ARE REQUIRED AND MUST BE PROVIDED TO THE BUILDING OFFICIAL UPON REQUEST.
- SITE BOUNDARIES, EASEMENTS, DRAINAGE DEVICES, RESTRICTED USE AREAS SHALL BE LOCATED PER CONSTRUCTION STAKING BY FIELD ENGINEER OR LICENSED SURVEYOR. PRIOR TO GRADING, AS REQUESTED BY THE BUILDING OFFICIAL, ALL PROPERTY LINES, EASEMENTS, AND RESTRICTED USE AREAS SHALL BE STAKED.
- NO GRADING OR CONSTRUCTION SHALL OCCUR WITHIN THE PROTECTED ZONE OF ANY OAK TREE AS REQUIRED PER TITLE CHAPTER 22-56 OF THE COUNTY OF LOS ANGELES ZONING CODE. THE PROTECTED ZONE SHALL MEAN THAT AREA WITHIN THE DRIP LINE OF AN OAK TREE EXTENDING THERE FROM A POINT AT LEAST FIVE FEET OUTSIDE THE DRIP LINE, OR 15 FEET FROM THE TRUNK(S) OF A TREE, WHICHEVER IS GREATER.
- TRANSFER OF RESPONSIBILITY: IF THE CIVIL ENGINEER, THE SOILS ENGINEER, OR THE ENGINEERING GEOLOGIST OF RECORD IS CHANGED DURING GRADING, THE WORK SHALL BE STOPPED UNTIL THE REPLACEMENT HAS AGREED IN WRITING TO ACCEPT THEIR RESPONSIBILITY WITHIN THE AREA OF TECHNICAL COMPETENCE FOR APPROVAL UPON COMPLETION OF THE WORK. IT SHALL BE THE DUTY OF THE PERMITEE TO NOTIFY THE BUILDING OFFICIAL IN WRITING OF SUCH CHANGE PRIOR TO THE RECOMMENCEMENT OF SUCH GRADING.
- ALL GRADES AND CONTOURS INDICATED ON THE PLANS ARE TO FINISHED SURFACE, AND NOT ROUGH GRADES. CONTRACTOR SHALL SUBTRACT THE STRUCTURAL THICKNESS OF PAVEMENTS AND TOP-SOIL THICKNESS IN LANDSCAPED AREAS, TO OBTAIN DESIRED ROUGH GRADES.
- EXCAVATIONS SHALL BE MADE IN ACCORDANCE WITH THE REGULATIONS OF THE STATE OF CALIFORNIA, DIVISION OF INDUSTRIAL SAFETY. ALL EXCAVATIONS SHALL BE STABILIZED WITHIN 30 DAYS OF INITIAL EXCAVATION. ALL TEMPORARY EXCAVATIONS SHALL BE DONE IN ACCORDANCE WITH THE RECOMMENDATIONS OF THE GEOTECHNICAL ENGINEER.
- ALL GEOTECHNICAL RECOMMENDATIONS IMPOSED BY THE CONSULTANT OR CONTAINED IN THE CONSULTANT GEOTECHNICAL INVESTIGATION REPORT ARE TO BE COMPLIED WITH AND ARE HEREBY MADE AN INTEGRAL PART OF THE GRADING SPECIFICATIONS AND NOTES.



GEOTECHNICAL REPORT DATED: \_\_\_\_\_  
REPORT NUMBER: \_\_\_\_\_  
PREPARED BY: **GEOTECHNOLOGIES, INC.**

- EXISTING TOPOGRAPHY SHOWN HEREON WAS TAKEN FROM A SURVEY DATED 10/27/17 BY CALIFORNIA SURVEYING SERVICES.
- THIS PLAN IS FOR GRADING, PAVING AND DRAINAGE PURPOSES ONLY AND DOES NOT CONSTITUTE APPROVAL OF BUILDINGS.
- ALL WATER LINES SHALL BE INSTALLED WITH 36" MINIMUM COVER FROM TOP OF PIPE TO FINISHED GRADE, UNLESS OTHERWISE NOTED. THRUST BLOCKS SHALL BE INSTALLED AT WATERLINE HORIZONTAL AND VERTICAL BENDS, TEES, CAPPED ENDS AND REDUCERS ACCORDING TO THE DETAILS PROVIDED ON THESE PLANS.
- CONTACT UNDERGROUND SERVICE ALERT (USA) AT (800-227-2600) TWO DAYS PRIOR TO ANY EXCAVATION.
- CONTRACTOR SHALL BE AWARE OF ALL OVERHEAD LINES AT ALL TIMES, SO AS NOT TO DISTURB THEM.
- REMOVAL OR RELOCATION OF ANY PUBLIC UTILITY LINES WITH THEIR RESPECTIVE OWNERS. SEPARATE PERMITS MAY BE REQUIRED.
- REPLACE ANY PUBLIC IMPROVEMENTS DAMAGED DURING CONSTRUCTION AT HIS OWN EXPENSE AND TO THE SATISFACTION OF THE BUILDING OFFICIAL. MATCH EXISTING MATERIALS, SURFACE TREATMENT, AND COLORS. SAME SHALL APPLY TO PERMANENT UTILITY TRENCH RESURFACING WITHIN PUBLIC RIGHT-OF-WAY.
- CUT AND FILL SLOPES SHALL BE NO STEEPER THAN TWO HORIZONTAL TO ONE VERTICAL.
- TEMPORARY STOCKPILING OF EXCESS MATERIAL ON SITE, INCLUDING PROTECTION MEASURES AND EROSION CONTROL, SHALL BE APPROVED BY THE BUILDING OFFICIAL, PRIOR TO EXCAVATION.
- REGISTERED DEPUTY GRADING INSPECTOR IS REQUIRED FOR SITE GRADING AND BUILDING FOUNDATION RELATED EARTHWORK.
- WRITTEN CONFIRMATION OF THE BURBANK FIRE DEPARTMENT CLEARANCE SHALL BE REQUIRED BY THE BUILDING OFFICIAL PRIOR TO COMMENCEMENT OF GRADING OR ANY CONSTRUCTION ACTIVITIES ON-SITE, AND PRIOR TO FINAL OCCUPANCY APPROVAL FOR THE BUILDING.
- OBTAIN ALL REQUIRED PERMITS, INCLUDING NPDES, FROM THE APPROPRIATE JURISDICTIONAL AGENCIES FOR THE DISCHARGE OF STORM WATER RUNOFF AND GROUNDWATER THAT MAY BE NECESSARY TO ACCOMPLISH THE EXCAVATIONS AND CONSTRUCTION WORK SHOWN ON THESE PLANS.
- ROUGH GRADING MUST BE APPROVED BY A FINAL ENGINEERING GEOLOGY AND SOILS ENGINEERING REPORT. AN AS-BUILT GEOLOGIC MAP MUST BE INCLUDED IN THE FINAL GEOLOGY REPORT. PROVIDE A FINAL REPORT STATEMENT THAT VERIFIES WORK WAS DONE IN ACCORDANCE WITH REPORT RECOMMENDATIONS AND CODE PROVISIONS (SECTION J105.12 OF THE COUNTY OF LOS ANGELES BUILDING CODE). THE FINAL REPORT(S) MUST BE SUBMITTED TO THE GEOTECHNICAL AND MATERIALS ENGINEERING DIVISION FOR REVIEW AND APPROVAL.
- FINAL GRADING MUST BE APPROVED BEFORE OCCUPANCY OF BUILDINGS WILL BE ALLOWED.

## LEGEND:

---	PROPERTY/ BOUNDARY LINE	(SS)	EXISTING SANITARY SEWER LINE	TW	TOP OF WALL	PVC	POLYVINYL CHLORIDE PIPE
---	LOT LINE	(PW)	EXISTING POTABLE WATER LINE	BW	BACK OF WALK	SD	STORM DRAIN
---	STREET CENTER LINE	(E)	EXISTING ELECTRIC LINE	TC	TOP OF CURB	SS	SANITARY SEWER
---	PROPOSED CONTOUR	(SSMH)	SEWER MANHOLE	FL	FLOW LINE	DW	DOMESTIC WATER LINE
---	PROPOSED HALF CONTOUR	CO	SANITARY SEWER CLEANOUT	FF	FINISHED FLOOR	PW	POTABLE WATER LINE
---	EXISTING TOPO CONTOUR	Q	STORM DRAIN MANHOLE	FS	FINISHED SURFACE	FW	FIRE WATER LINE
---	RETAINING WALL/SITE WALL	Q	STREET LIGHT	R/W	RIGHT OF WAY	T	TELEPHONE LINE
---	STORM DRAIN	Q	ELECTRICAL TRANSFORMER	TG	TOP OF GRATE	G	GAS LINE
---	SIDEWALK CULVERT / PARK DRAIN	Q	PROPOSED SPOT ELEVATION	STA	STATION	E	ELECTRICAL LINE
---	FLOW LINE	Q	JOIN SPOT ELEVATION	EL	ELEVATION	POC	POINT OF CONNECTION
		Q	EXISTING TOPO ELEVATION	INV	INVERT	TOP	TOP OF PIPE
		Q		CB	CATCH BASIN	TB	TOP OF BERM
		Q		MH	MANHOLE	TCB	TOP OF CONCRETE BEAM
		Q		S	SLOPE	BOE	BOTTOM OF OVER-EXCAVATION
		Q		Ⓜ	CURVE NUMBER	RG	ROUGH GRADING
		Q		RCP	REINFORCED CONCRETE PIPE		

ADA COMPLIANT PATH OF TRAVEL

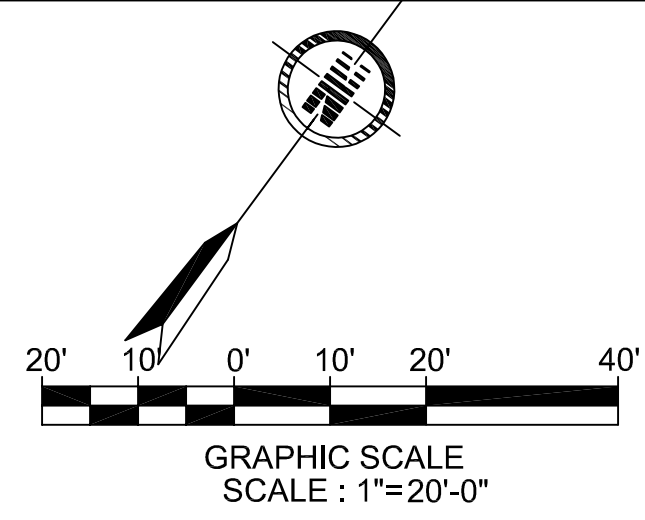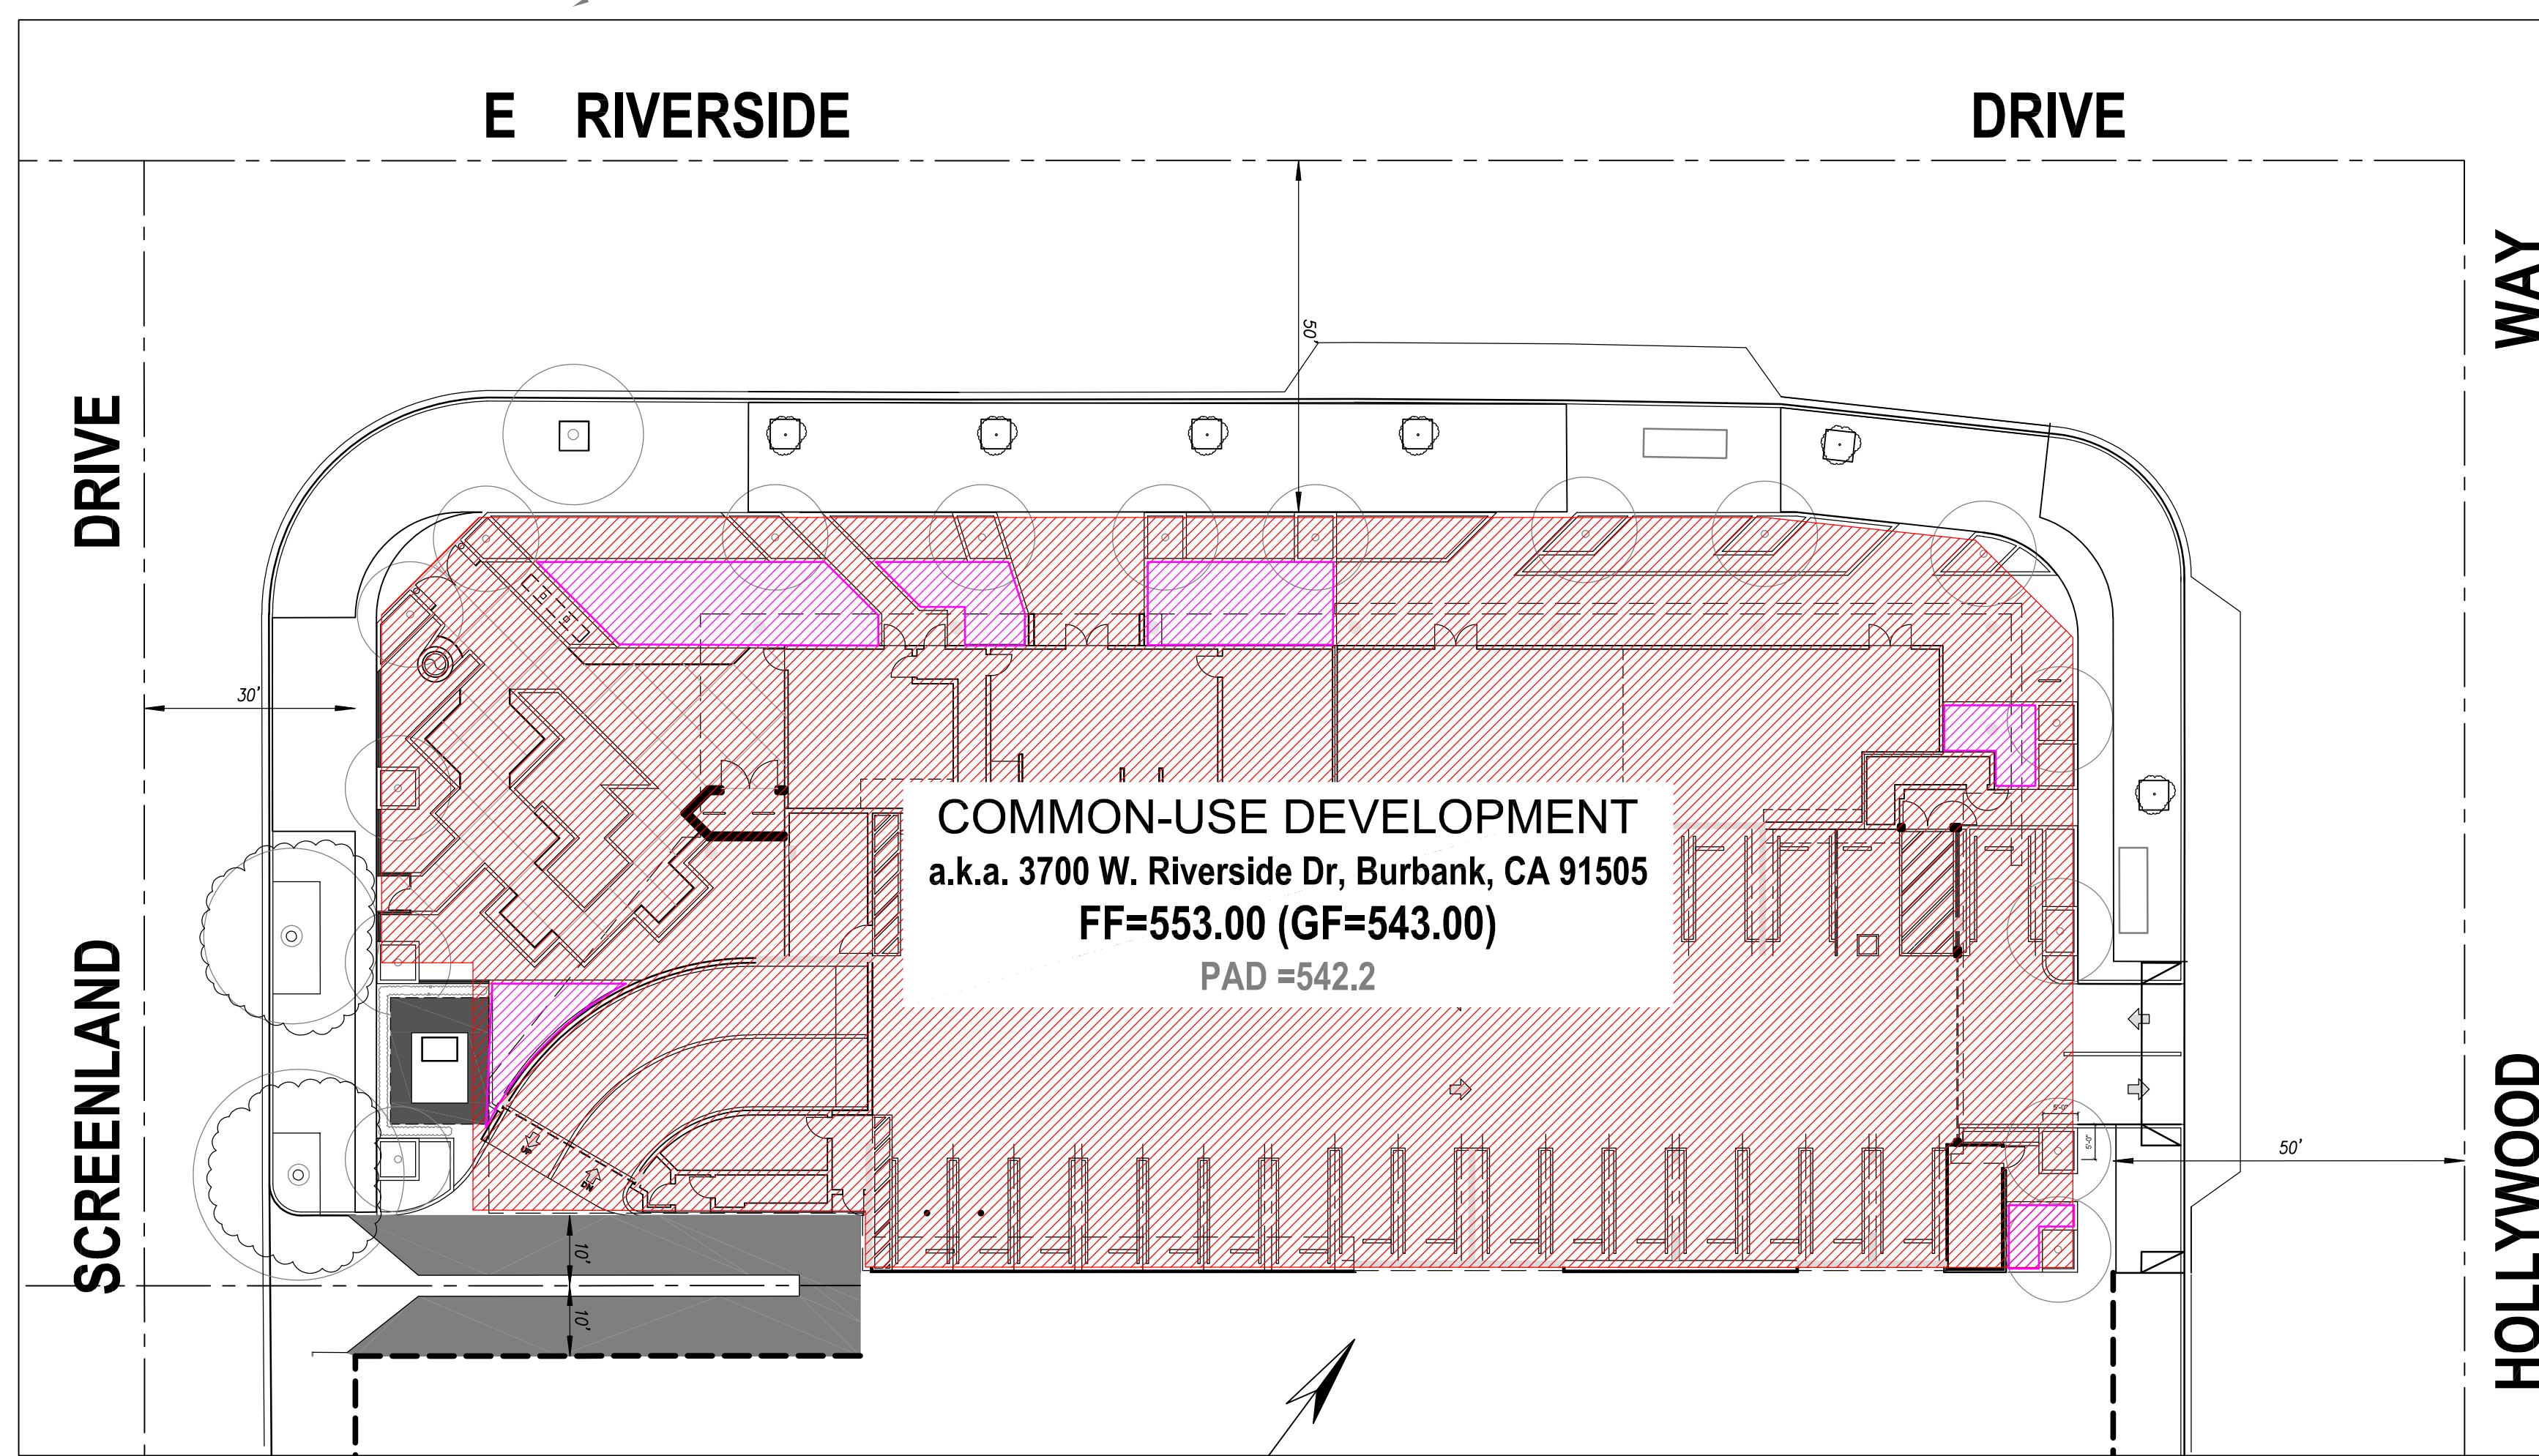

## CALIFORNIA CODE OF REGULATIONS

- ### APPLICABLE STATE CODES AND STANDARDS
- PART 1 2016 CALIFORNIA BUILDING STANDARDS ADMINISTRATIVE CODE, TITLE 24 C.C.R.
  - PART 2 2016 CALIFORNIA BUILDING CODE, TITLE 24 C.C.R. (2015 INTERNATIONAL BUILDING CODE OF THE INTERNATIONAL CODE COUNCIL, WITH 2016 CALIFORNIA AMENDMENTS)
  - PART 3 2016 CALIFORNIA ELECTRICAL CODE, TITLE 24, C.C.R. (2015 NATIONAL ELECTRICAL CODE OF THE NATIONAL FIRE PROTECTION ASSOCIATION, NFPA WITH 2016 CALIFORNIA AMENDMENTS)
  - PART 4 2016 CALIFORNIA MECHANICAL CODE, TITLE 24 C.C.R. (2015 UNIFORM MECHANICAL CODE OF THE INTERNATIONAL ASSOCIATION OF PLUMBING AND MECHANICAL OFFICIALS, IAPMO WITH 2016 CALIFORNIA AMENDMENTS)
  - PART 5 2016 CALIFORNIA PLUMBING CODE, TITLE 24, C.C.R. (2015 UNIFORM PLUMBING CODE OF THE INTERNATIONAL ASSOCIATION OF PLUMBING AND MECHANICAL OFFICIALS, IAPMO WITH 2016 CALIFORNIA AMENDMENTS)
  - PART 6 2016 CALIFORNIA ENERGY CODE, TITLE 24 C.C.R.
  - PART 9 2016 CALIFORNIA FIRE CODE, TITLE 24 C.C.R. (2015 INTERNATIONAL FIRE CODE OF THE INTERNATIONAL CODE COUNCIL WITH 2016 CALIFORNIA AMENDMENTS)
  - PART 10 2016 CALIFORNIA EXISTING BUILDING CODE, TITLE 24, C.C.R. (2015 INTERNATIONAL EXISTING BUILDING CODE OF THE INTERNATIONAL CODE COUNCIL, WITH AMENDMENTS)
  - PART 11 2016 CALIFORNIA GREEN BUILDING STANDARDS CODE, (CALGREEN), CHAPTER 5, TITLE 24 C.C.R.
  - PART 12 2016 CALIFORNIA REFERENCED STANDARDS CODE, TITLE 24 C.C.R.
- ### APPLICABLE FEDERAL CODES AND STANDARDS
- AMERICANS WITH DISABILITIES ACT (ADA), TITLE II, OR TITLE III
  - FOR TITLE II: UNIFORM FEDERAL ACCESSIBILITY STANDARDS (UFAS) OR ADA STANDARDS FOR ACCESSIBLE DESIGN (APPENDIX A OF 28 CFR PART 36), (28 CFR 35.151(c))

## EARTHWORK SUMMARY:

(DOES NOT INCLUDE PAVEMENT AND TOP SOIL REMOVAL)

DESCRIPTION	CUT (CY)	FILL (CY)
RAW :	8,780 CY	0 CY
REMEDIAL :	0 CY	0 CY
FOUNDATION :	270 CY	0 CY
SEPTIC SYSTEM :	0 CY	0 CY
EXEMPT :	0 CY	0 CY
DISCRETIONARY :	0 CY	0 CY
TOTAL (CUT + FILL):	9,050 CY	
NET EXPORT :		(8,050 CY)

THE ABOVE LISTED QUANTITIES REFLECT THE ENGINEER'S ESTIMATE OF THE ACTUAL VOLUMES OF MATERIAL CUT AND FILLED. THESE QUANTITIES ARE FOR DESIGN AND BONDING PURPOSES ONLY. SHRINKAGE, SWELL, SUBSIDENCE, AND ANY REMOVALS ARE BASED ON DATA OBTAINED FROM THE SOILS REPORT. FIELD CONDITIONS DURING CONSTRUCTION MAY VARY RESULTING IN ACTUAL EARTHWORK QUANTITIES DIFFERENT FROM THOSE ESTIMATES ABOVE.

## EARTHWORK LEGEND:


---	PROPERTY BOUNDARY
---	LIMITS OF GRADING ( DAYLIGHT) LINE
[Red Box]	RAW CUT
[Blue Box]	RAW FILL
[Green Box]	EXEMPT (BASEMENT / UNDERGROUND)
[Yellow Box]	EXEMPT (FIRE DEPT. / EMERGENCY ACCESS)
[Purple Box]	EXEMPT (STORMWATER BMP IMPLEMENTATION)
[Pink Box]	EXEMPT (OFF-SITE PER PUBLIC WORKS REQ.)

REVISION INFORMATION

No.	Date	Revised
1	09/22/2019	CUP AND DR SUBMITTAL
2	09/22/2019	CUP & DR - PLAN UPDATES

PROJECT NAME:  
**3700 W. Riverside  
Mixed-Use Development**  
3700 W. RIVERSIDE DR.  
BURBANK, CA 91505

PREPARED FOR:  
**3700 W. RIVERSIDE  
INVESTMENTS, LLC**  
127 N. MADISON AVE.  
SUITE 200  
PASADENA, CALIF 91101

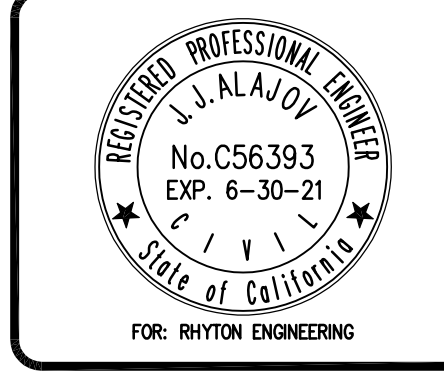


**SUSTAINABLE SITE SOLUTIONS**  
13351 Riverside Engineering  
(818) 478-7788 (818) 990-9900  
www.RhytonCivil.com

SHEET TITLE:  
**TITLE SHEET  
& GENERAL  
NOTES**

CHECKED BY: WHR, JJA  
PROJECT No: 1BAL1004.00  
DATE: 09/19/2019  
SCALE: AS SHOWN  
SHEET ID No: **C01**  
SHEET 1 of 4



CUP AND DR SUBMITTAL

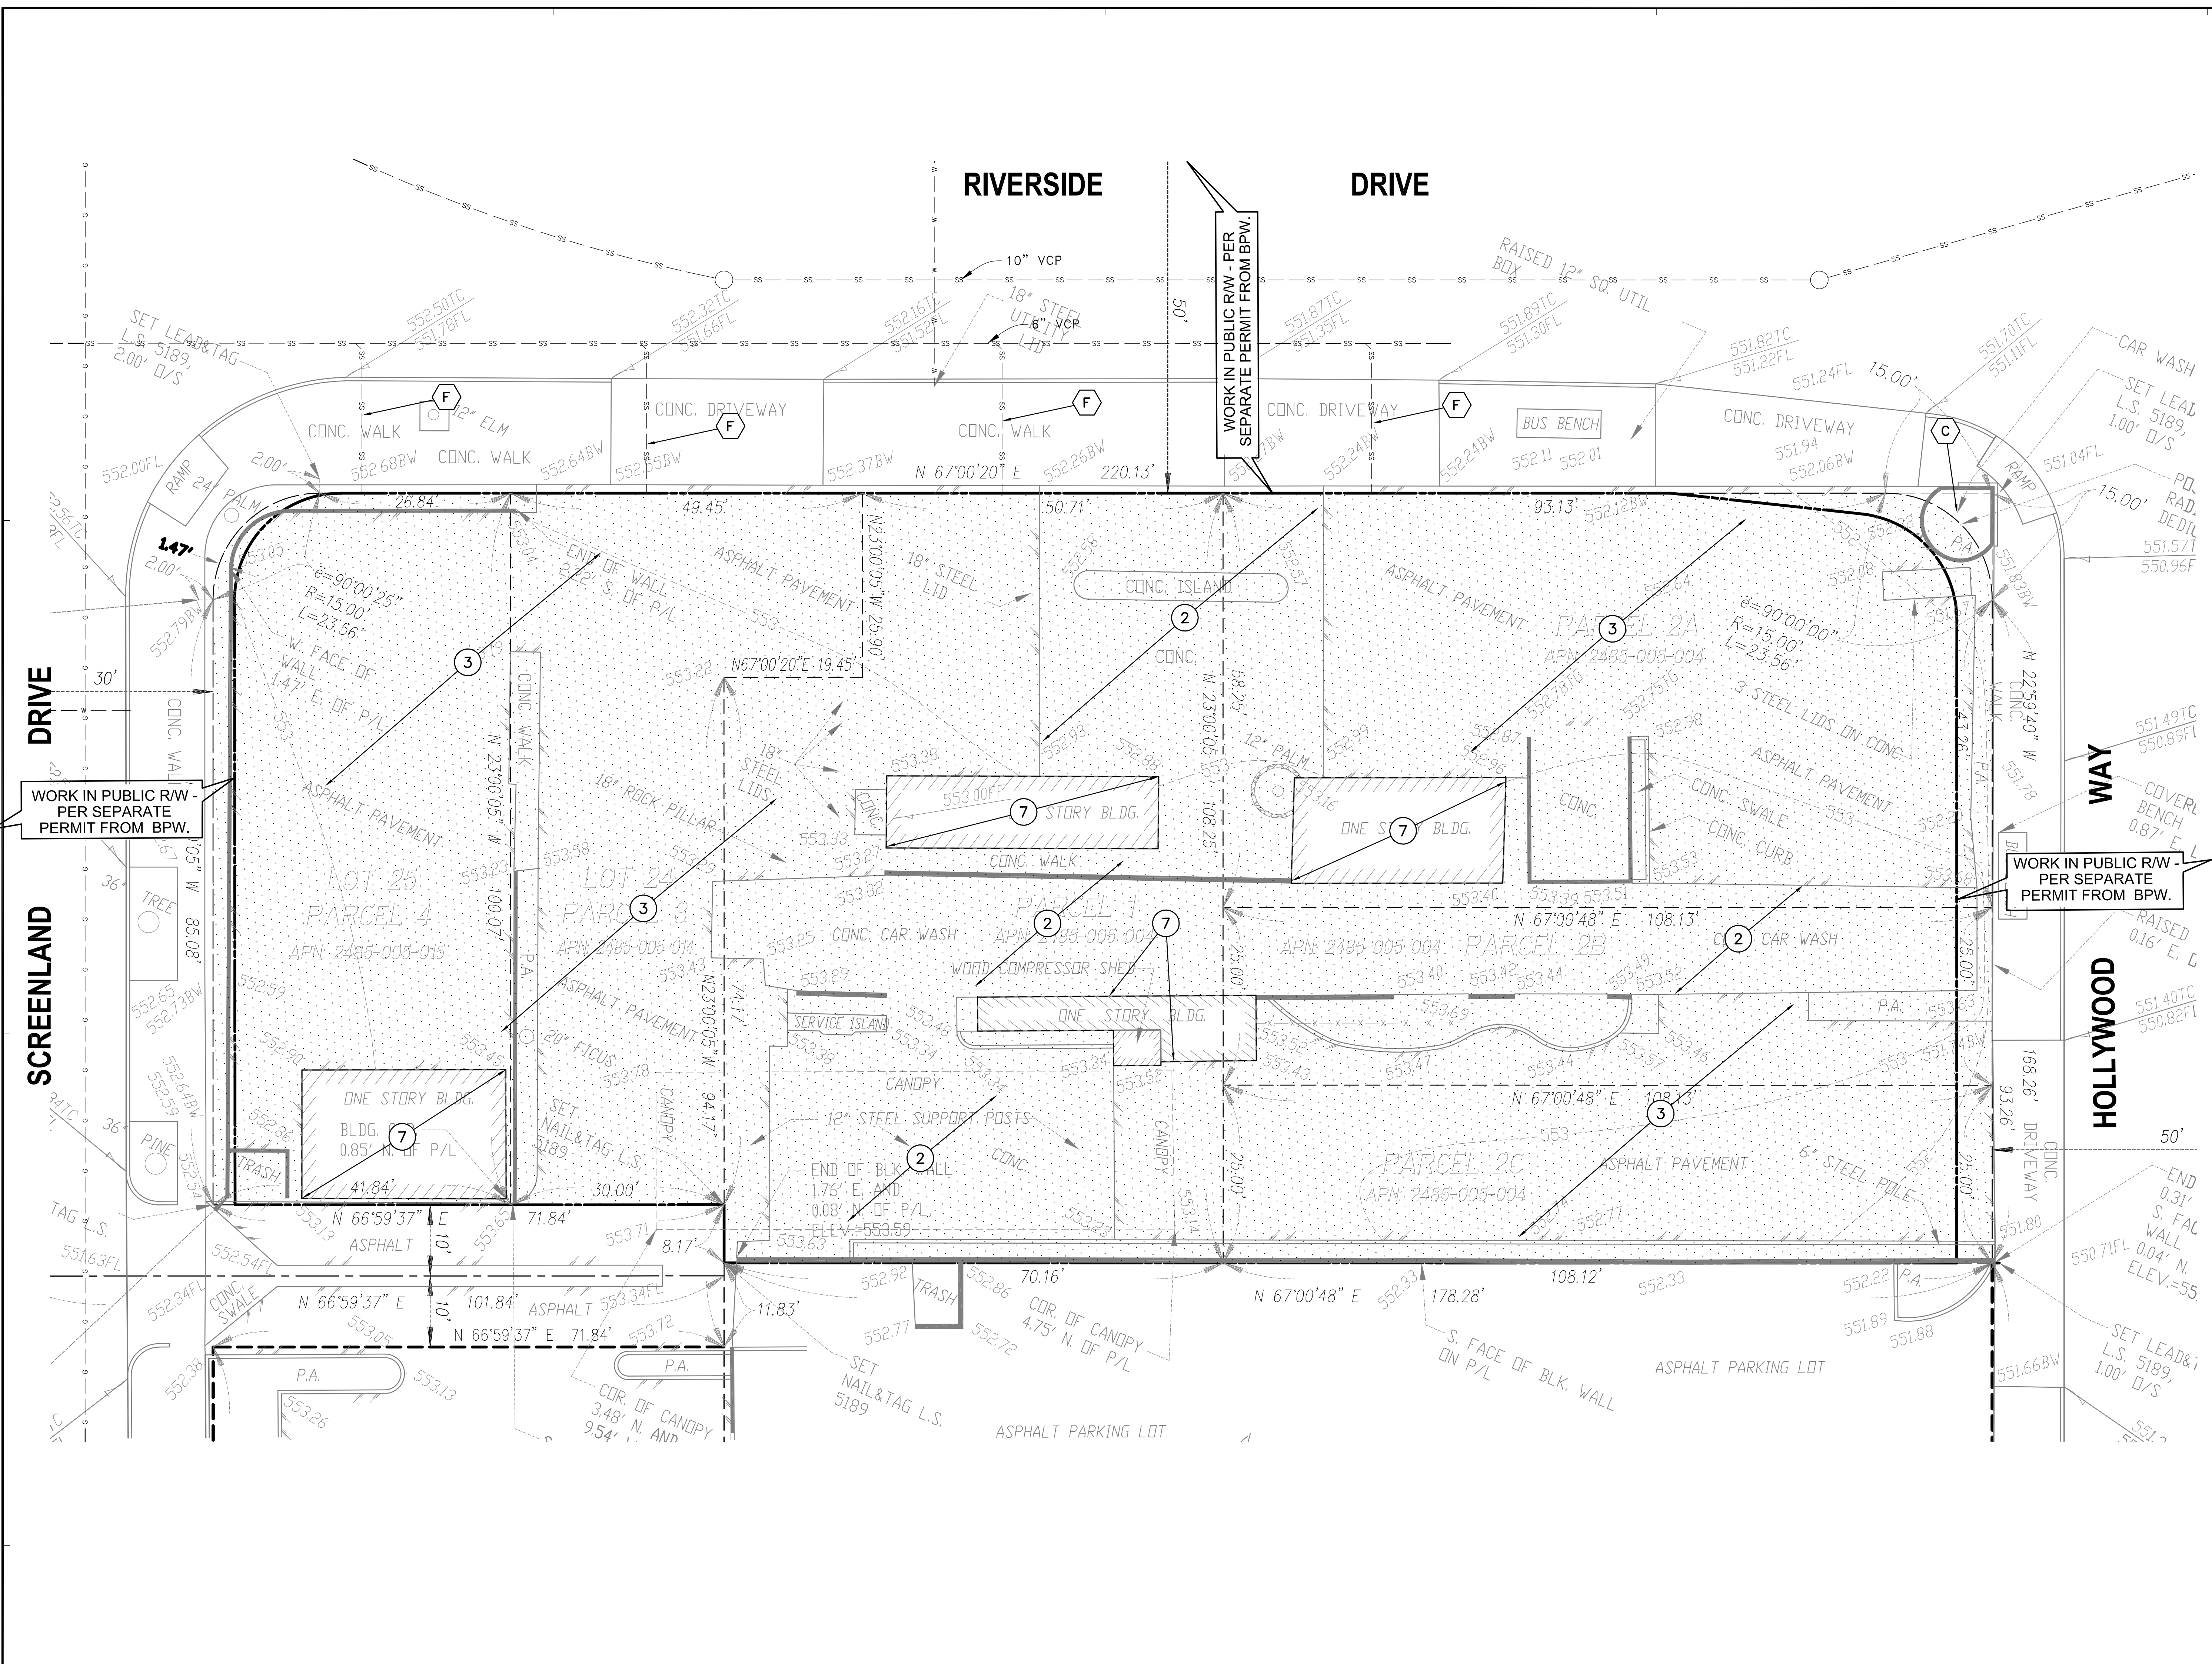

**LEGEND NOTES**

LEGEND NOTES ARE COMMON TO ALL SIMILAR PLANS  
SOME NOTES MAY NOT APPLY TO THIS SHEET

- DEMOLITION KEY NOTES:**
1. SAWCUT PAVEMENT AT A NICE EVEN LINE ALONG THE PROPOSED JOIN LINES AROUND THE PROJECT OR ALONG THE NEAREST EXISTING CONCRETE PAVEMENT JOINT.  
NOTE: REMOVALS WITHIN PUBLIC RIGHT-OF-WAY REQUIRE SEPARATE PERMIT FROM LADWP, BUREAU OF ENGINEERING.
  2. REMOVE EXISTING CONC. PAVEMENT AND AGGREGATE BASE INTERFERING WITH THE PROPOSED CONSTRUCTION AND CLEAR THE SITE. REUSE AND RECYCLE MATERIALS AS REQUIRED.
  3. REMOVE EXISTING ASPHALT PAVEMENT AND AGGREGATE BASE INTERFERING WITH THE PROPOSED CONSTRUCTION AND CLEAR THE SITE. REUSE AND RECYCLE MATERIALS AS REQUIRED.
  4. REMOVE EXISTING CONCRETE CURB AND BASE.
  5. POWER POLE WITH ELECTRICAL AND TELEPHONE WIRES - TO BE DISCONNECTED AND REMOVED BY LADWP PERSONNEL ONLY. CONTRACTOR TO COORDINATE WORK AND TIMING WITH LADWP - POWER SERVICES.
  6. REMOVE OR RELOCATE EXISTING TREE, TREE BALL OR LARGE SHRUB. REFER TO LANDSCAPE DRAWINGS FOR DETAILS.
  7. REMOVE EXISTING BUILDINGS AND FOUNDATIONS - PER SEPARATE PERMIT.
  8. REMOVE EXISTING FENCE, POSTS AND FOOTINGS.
  9. REMOVE EXISTING BLOCK WALL (FENCE) AND FOOTINGS.
  10. REMOVE EXISTING STEEL BOLLARD AND FOOTINGS.
  11. GENERAL NOTE: DISCONNECT, CUT AND CAP ALL UTILITY SERVICES AT THE PERIMETER OF THE PROJECT. COORDINATE DISCONNECTION WITH THEIR RESPECTIVE OWNERS. REMOVE ALL UNDERGROUND UTILITY VAULTS, MANHOLES, PULLBOXES, CLEANOUTS AND DRAIN INLETS PRIOR TO BEGINNING OF EXCAVATION. REPORT SALVAGEABLE ITEMS TO THE OWNER AND OBTAIN DIRECTION PRIOR TO DISPOSAL.

- SALVAGE KEY NOTES:**
- A. PROTECT IN PLACE AND MAINTAIN INTEGRITY OF EXISTING SECURITY FENCE AND FOOTINGS AROUND THE PERIMETER OF THE SITE.
  - B. PROTECT IN PLACE AND MAINTAIN THE INTEGRITY OF EXISTING PUBLIC TREES. PUBLIC TREE REMOVALS REQUIRE SEPARATE PERMIT FROM STREET SERVICES DEPARTMENT. COORDINATE THE WORK WITH THE STREET IMPROVEMENT PLANS.
  - C. SALVAGE AND RETURN TO OWNER. REFER TO ARCHITECTURAL PLANS FOR ADDITIONAL DETAILS.
  - D. PROTECT IN PLACE AND MAINTAIN THE INTEGRITY OF OVERHEAD POWER LINE AND POLE AND GUY WIRE. REMOVALS OF POWER POLES, GUY WIRES AND CONDUCTORS SHALL BE DONE BY LADWP ONLY.
  - E. PROTECT IN PLACE AND MAINTAIN THE INTEGRITY OF EXISTING UNDERGROUND STORM DRAIN CATCH BASINS AND PIPES. COORDINATE REQUIRED NEW CONNECTIONS WITH THE SITE UTILITIES DRAWINGS.
  - F. PROTECT IN PLACE AND MAINTAIN THE INTEGRITY OF EXISTING SANITARY SEWER UNDERGROUND PIPES AND HOUSE LATERALS. PROTECT ALL EXISTING SEWER HOUSE LATERALS FROM DAMAGE DURING DRILLING FOR SOLDIER PILES. REFER TO THE SITE UTILITIES PLAN FOR APPROXIMATE HOUSE LATERAL LOCATIONS.
  - G. PROTECT IN PLACE AND MAINTAIN INTEGRITY OF EXISTING CONCRETE CURB AND GUTTER. REMOVALS OF PUBLIC SIDEWALKS, DRIVEWAY APPROACHES, CURBS AND GUTTERS IS PER SEPARATE PLAN FROM LADWP - BOE. COORDINATE WITH THE STREET IMPROVEMENT PLANS.

REVISION INFORMATION

No.	Date	Revision
1	09/12/2019	CUP AND DR SUBMITTAL
2	09/12/2019	CUP & DR - PLAN UPDATES

PROJECT NAME:  
**3700 W. Riverside  
Mixed-Use Development**  
3700 W. RIVERSIDE DR.  
BURBANK, CA 91605

PREPARED FOR:  
**3700 W. RIVERSIDE  
INVESTMENTS, LLC**  
127 N. MADISON AVE.  
SUITE 200  
PASADENA, CALIF 91101



**SUSTAINABLE SITE SOLUTIONS**  
13341 E. 15th Ave, Suite 100, Denver, CO 80231  
(818) 478-7788 (818) 980-9803 www.RhytonCivil.com

**ABBREVIATIONS:**

AC	ASPHALTIC CONCRETE
BLDG	BUILDING
CMU	CONCRETE MASONRY UNIT
CONC	CONCRETE
ELEC	ELECTRIC, ELECTRICAL
EX. OR EXIST.	EXISTING
FG	FINISHED GRADE (LANDSCAPE)
FS	FINISHED SURFACE (HARDSCAPE)
FH	FIRE HYDRANT
FL	FLOW LINE
MH	MANHOLE
PA	PLANTER AREA
PCC	PORTLAND CEMENT CONCRETE
SD	STORM DRAIN
SF	SQUARE FEET
SSMH	SANITARY SEWER MANHOLE
SS	SANITARY SEWER
SDMH	STORM DRAIN MANHOLE
TC	TOP OF CURB

**LEGEND:**

	LIMIT OF WORK LINE
	SAWCUT LINE
	REMOVE EXISTING IMPROVEMENTS INTERFERING WITH PROPOSED CONSTRUCTION.
	AC PAVT REMOVAL AND TRENCH RESURFACING
	REMOVE EXIST CONC PWMT & BASE

**NOTICE TO CONTRACTOR:**

1. THE CONTRACTOR IS RESPONSIBLE FOR MAINTAINING ADEQUATE DRAINAGE OF THE SITE AND FOR STORMWATER QUALITY MITIGATION AND MAINTENANCE DURING THE INTERIM CONDITIONS OF SITE CLEARING AND DEMOLITION.
2. FOR BUILDINGS OR SITE FURNISHINGS REMOVALS AND SALVAGE ITEMS REFER TO THE ARCHITECTURAL SITE DEMOLITION PLAN. COORDINATE DELIVERY AND STORAGE LOCATION FOR SALVAGED ITEMS WITH THE OWNER.
3. THE CONTRACTOR IS RESPONSIBLE FOR OBTAINING A PERMIT FROM THE CITY OF BURBANK DEPARTMENT OF PUBLIC WORKS. IN ORDER TO PERFORM ANY OFF-SITE CIVIL AND RELATED WORK, IT SHOULD BE MADE CLEAR THAT PART OF THAT PROCESS WILL REQUIRE THE CONTRACTOR TO PROVIDE A TRAFFIC CONTROL PLAN TO SATISFY CITY OF BURBANK REQUIREMENTS. CONTRACTOR'S BID SHALL INCLUDE THE COSTS OF TEMPORARY TRAFFIC CONTROL REQUIRED BY THE CITY OF BURBANK TO ACCOMPLISH WORK UNDER CITY PERMIT(S).

NOTE: FOR REMOVAL, RELOCATION OR PROTECTION OF UTILITY LINES, PLEASE REFER TO THE SITE UTILITY PLAN.

**NOT FOR CONSTRUCTION**




Call 2 Full Working Days in Advance

CUP AND DR SUBMITTAL

**SITE DEMOLITION PLAN**

CHECKED BY: WHR, JJA  
PROJECT No: 18AL1004.00  
DATE: 09/19/2019  
SCALE: AS SHOWN  
SHEET NO. C02  
SHEET 2 OF 5

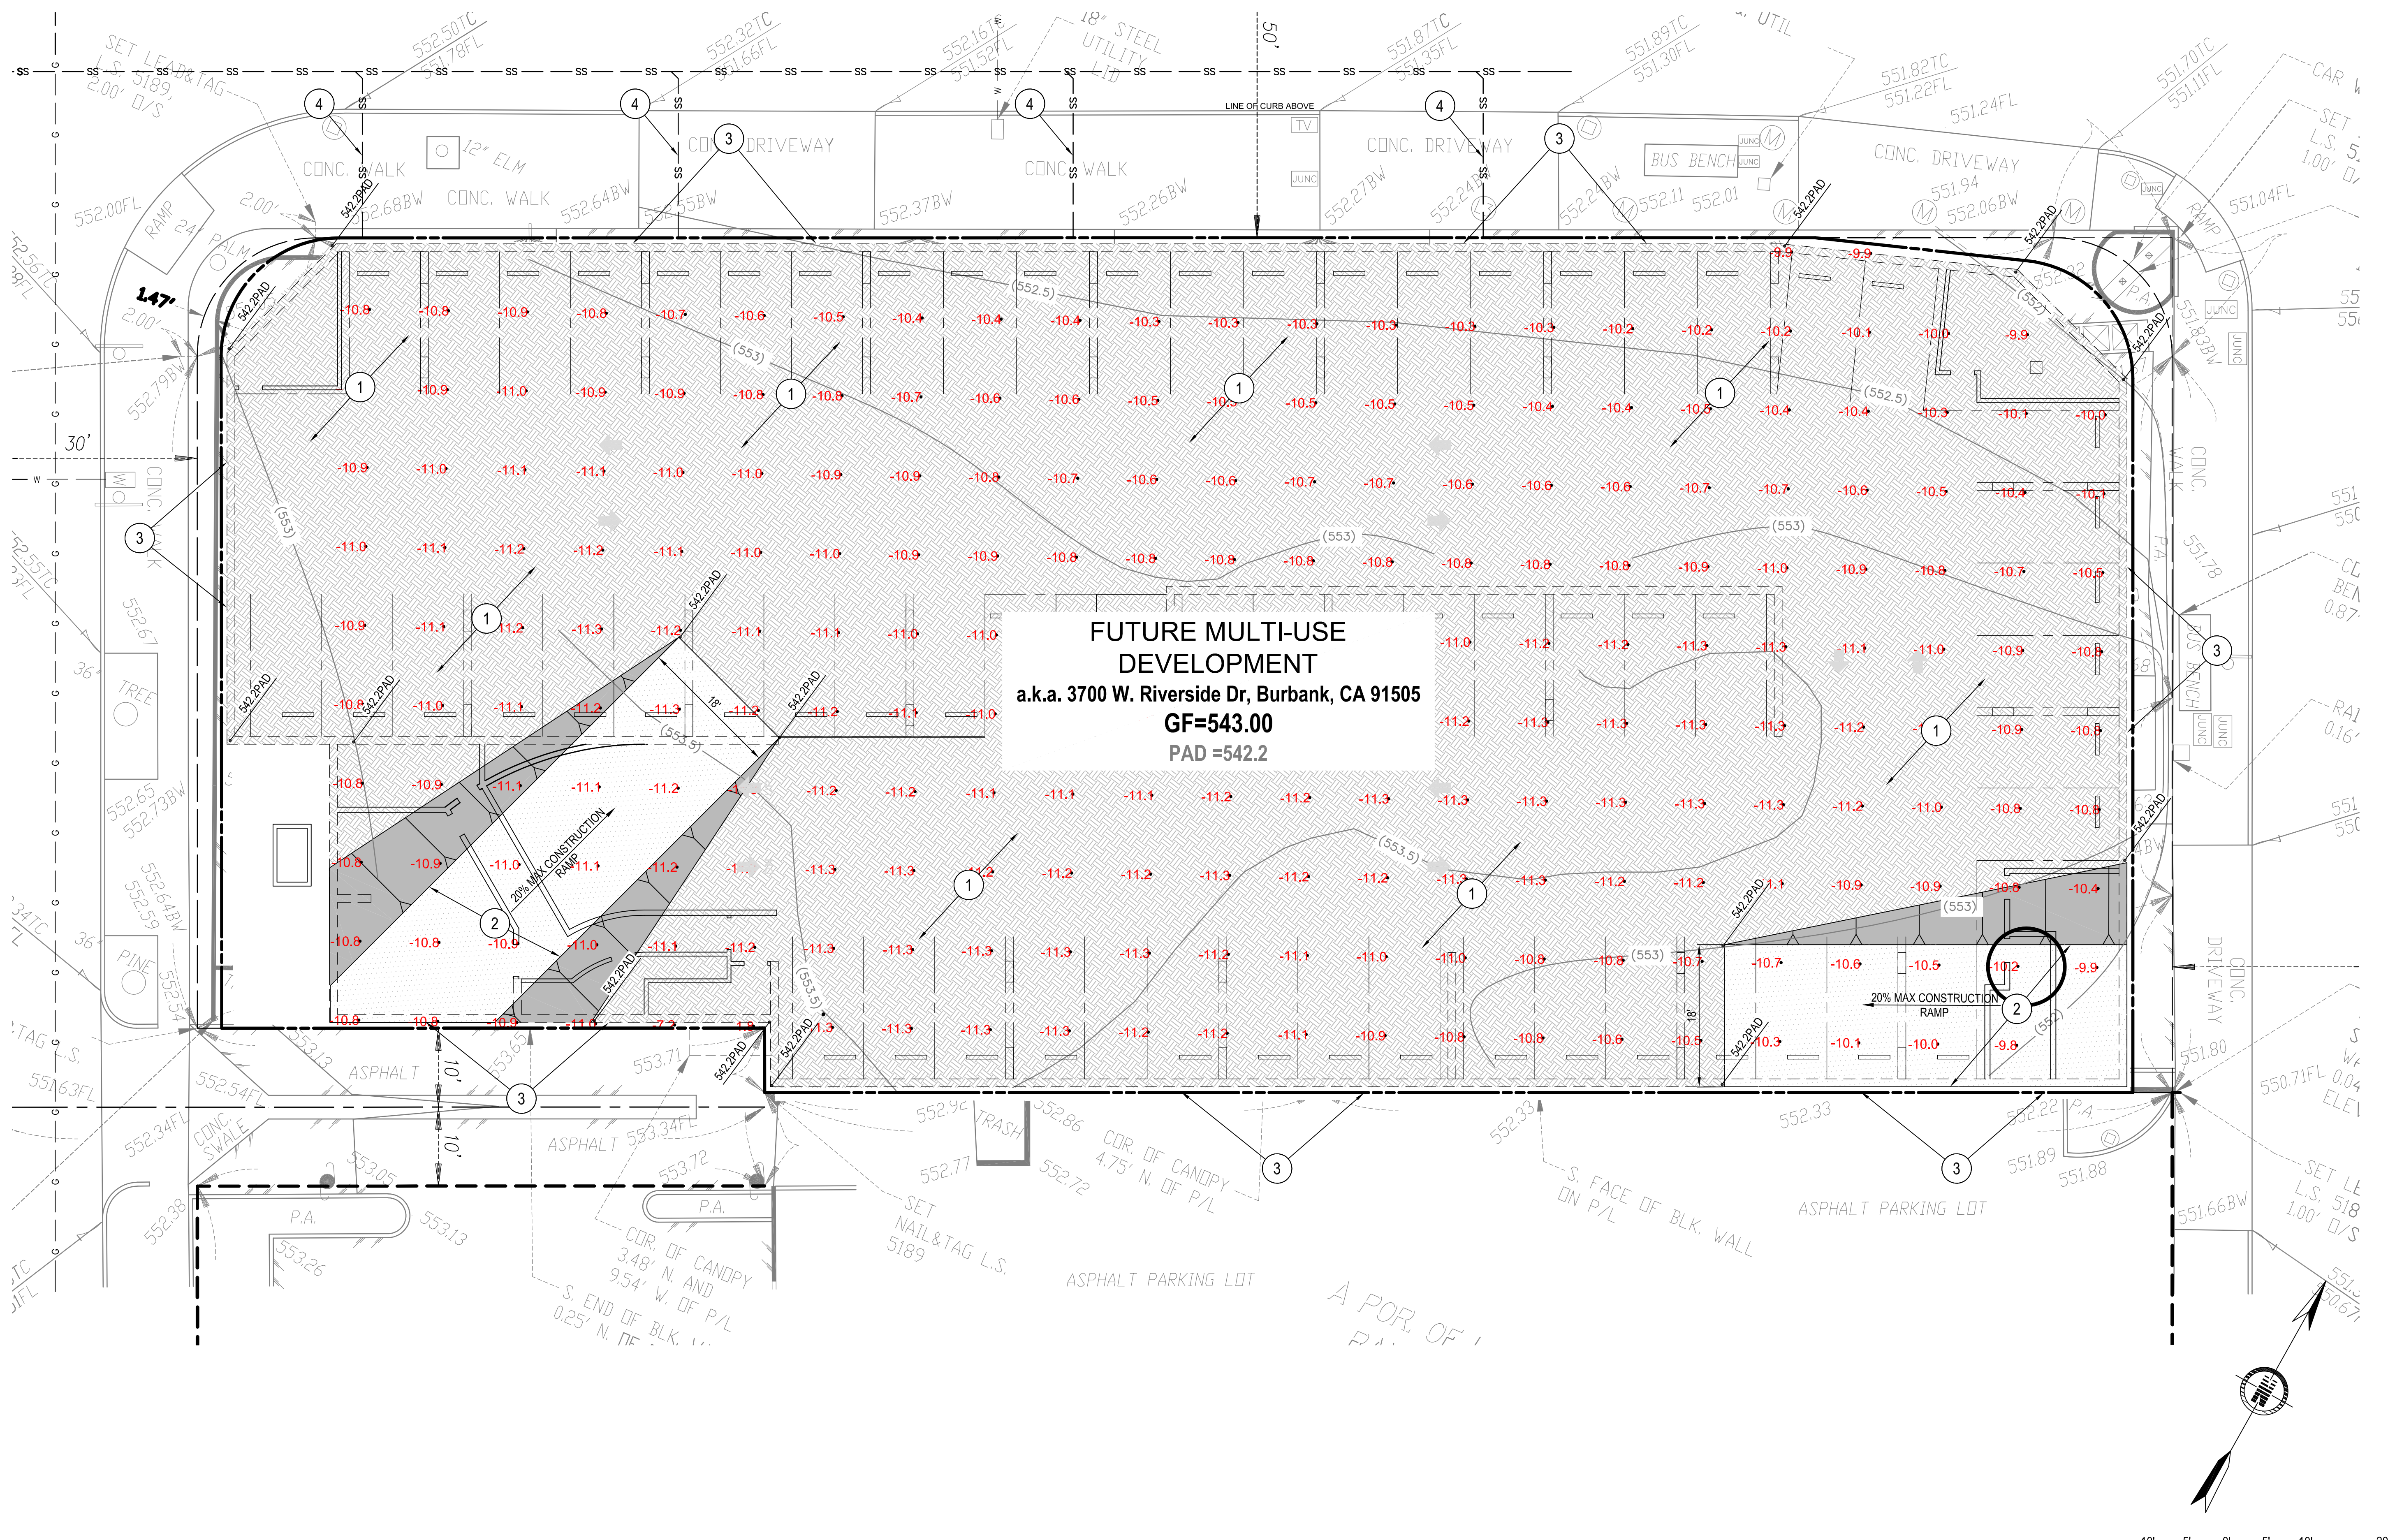

**PLAN**

**EARTHWORK SUMMARY:**

(DOES NOT INCLUDE PAVEMENT AND TOP SOIL REMOVAL)

DESCRIPTION	CUT (CY)	FILL (CY)
RAW :	8,780 CY	0 CY
REMEDIAL :	0 CY	0 CY
FOUNDATION :	270 CY	0 CY
SEPTIC SYSTEM :	0 CY	0 CY
EXEMPT :	0 CY	0 CY
DISCRETIONARY :	0 CY	0 CY
<b>TOTAL (CUT + FILL) :</b>	<b>9,050 CY</b>	
<b>NET EXPORT :</b>	<b>9,050 CY</b>	

THE ABOVE LISTED QUANTITIES REFLECT THE ENGINEER'S ESTIMATE OF THE ACTUAL VOLUMES OF MATERIAL CUT AND FILLED. THESE QUANTITIES ARE FOR DESIGN AND BONDING PURPOSES ONLY. SHRINKAGE, SWELL, SUBSIDENCE, AND ANY REMOVALS ARE BASED ON DATA OBTAINED FROM THE SOILS REPORT. FIELD CONDITIONS DURING CONSTRUCTION MAY VARY RESULTING IN ACTUAL EARTHWORK QUANTITIES DIFFERENT FROM THOSE ESTIMATES ABOVE.

**EARTHWORK DEPTH LEGEND:**

-10.9	-10.8	DEPTH OF RAW CUT EXCAVATION (FEET)
-10.5	-10.2	
+4.2	+4.8	DEPTH OF RAW FILL (FEET)
+3.8	+4.4	

**LEGEND NOTES**

- LEGEND NOTES ARE COMMON TO ALL SIMILAR PLANS SOME NOTES MAY NOT APPLY TO THIS SHEET
- EXCAVATE BASEMENT LEVEL OF PARKING STRUCTURE INTO FIRM AND UNDISTURBED ALLUVIUM. OVEREXCAVATE AND RECOMPACT UNFAVORABLE SOILS ( IF REQUIRED) AS PER THE GEOTECHNICAL REPORT RECOMMENDATIONS. EXCAVATE FOR LINEAR AND SPREAD FOOTINGS. GEOTECHNICAL ENGINEER TO INSPECT BOTTOM PRIOR TO INSTALLATION OF REINFORCEMENT AND POURING OF CONCRETE
  - LEAVE TEMPORARY ACCESS RAMP TO BOTTOM OF EXCAVATION. RAMP SHALL BE 18 FEET WIDE MINIMUM, AND ITS RUNNING SLOPE SHALL NOT EXCEED 20%.
  - INSTALL TEMPORARY SHORING, (SOLDIER PILES AND WOOD LAGGING) PER SEPARATE PLANS AND PERMIT, AS RECOMMENDED IN THE GEOTECHNICAL REPORT.
  - CONTRACTOR SHALL FIELD VERIFY SEWER HOUSE CONNECTIONS, AND PROTECT THEM DURING CONSTRUCTION OF SOLDIER PILES.

**GENERAL SHORING NOTES:**


- SHORING PLANS, DETAILS AND CALCULATIONS FOR TEMPORARY EXCAVATION SUPPORT WILL BE PROVIDED BY A LICENSED STRUCTURAL ENGINEER.
- SOLDIER PILES FOR EXCAVATION LESS THAN 12 FEET WILL BE DESIGNED AS CANTILEVERED, SPACED AT 7'-6" TO 8'-0" APART ( 2 PILE DIAMETERS APART MINIMUM).
- ALL CONSTRUCTION SHALL CONFORM TO REQUIREMENTS OF INDUSTRIAL SAFETY DIVISION OF THE STATE OF CALIFORNIA AND OF LOCAL BUILDING CODES.
- CONTRACTOR SHALL PROVIDE PROPER DRAINAGE FOR EXCAVATION PROTECTION . CONTRACTOR SHALL COORDINATE SHORING WITH STRUCTURAL DRAWINGS TO INSURE PROVISIONS FOR POCKETS, BLOCK-OUTS, OFFSETS, STEPPED FOOTINGS AND ANY OTHER ITEMS AFFECTED BY SHORING.
- CONTRACTOR SHALL IDENTIFY ALL EXISTING SEWER HOUSE CONNECTIONS IN THE FILED TO AVOID DRILLING THRU THEM AND FILLING THEM WITH CONCRETE.
- A LICENSED SURVEYOR SHALL LAY OUT PERIMETERS OF STRUCTURES ON THE SITE AND SHALL PROVIDE A CERTIFICATE PLAN INDICATING THE SHORING IS LOCATED IN ACCORDANCE WITH APPROVED PLANS. SUBMIT CERTIFICATE OR PLAN TO CITY OF BURBANK PRIOR TO COMMENCING
- SHORING PILES SHALL BE SURVEY MONITORED WEEKLY FOR LINE AND GRADE BY A LICENSED SURVEYOR. ANY ONE INCH MOVEMENT SHALL BE ANALYZED BY THE SOILS ENGINEER AND AN APPROVED REMEDIAL SHORING PLAN PREPARED. ANY MOVEMENT OF 2-INCHES OR MORE REQUIRE THAT REMEDIAL SHORING INSTALLATION BE MADE TO PREVENT ADDITIONAL MOVEMENT PRIOR TO FURTHER CONSTRUCTION. PROVIDE DEPUTY INSPECTOR IS REQUIRED. INSPECTOR QUALIFICATIONS SHALL BE APPROVED BY THE CITY OF BURBANK PRIOR TO START OF SHORING AND EXCAVATION.
- A REGISTERED DEPUTY GRADING INSPECTOR IS REQUIRED ON ALL SHORING WORK INCLUDING SLOT-CUTS.
- SOIL ENGINEER'S REPRESENTATIVE SHALL REVIEW SHORING DESIGN, EXCAVATION AND INSTALLATION OF SHORING SHALL BE PERFORMED UNDER THEIR CONTINUOUS INSPECTION.
- HEAVY EQUIPMENT OR CRANES OR STOCK PILING OF MATERIALS SHALL NOT BE LOCATED ADJACENT TO SHORING BULKHEADS EXCEPT WHERE SPECIFICALLY PROVIDED AND APPROVED BY SHORING DESIGN ENGINEER.
- REMOVE TOP OF STEEL SOLDIER PILES AND LAGGING TO 12-0" BELOW SIDEWALK GRADE IN PUBLIC RIGHT OF WAY.
- RECORD A "MAINTENANCE OF BUILDING SUPPORT" AFFIDAVIT BY THE OWNER OF SUBJECT PROPERTY WHICH WILL INFORM FUTURE OWNERS OF ADJOINING SITE THAT THE LATERAL SUPPORT OF A PORTION OF BUILDING FOUNDATION ON ADJOINING PROPERTY IS PROVIDED BY SUBTERRANEAN WALLS OF THE BUILDING ON SUBJECT SITE. AFFIDAVIT MUST BE APPROVED PRIOR TO RECORDING.
- HEAVY EQUIPMENT OR CRANES SHALL NOT BE LOCATED ADJACENT TO THE SHORING BULKHEAD EXCEPT WHERE SPECIFICALLY PROVIDED FOR IN THE DESIGN.
- CAL-OSHA PERMIT SHALL BE OBTAINED FOR ALL EXCAVATIONS DEEPER THAN 5'-0" VERTICAL AND FOR SHORING. SHAFTS
- VERTICAL AND DIAGONAL SHAFTS ARE TO BE MACHINE DRILLED AND ACCURATELY LOCATED SO THAT SOLDIER PILES ARE IN PROPER RELATION TO NEW BASEMENT WALL AND FOOTINGS. PROVIDE PROTECTION AGAINST SLOUGHING OR CAVING, AS REQUIRED.

REVISION INFORMATION

No.	Date	Revision
1	09/12/2019	CUP AND DR SUBMITTAL
2	09/12/2019	CUP & DR - PLAN UPDATES

PROJECT NAME:  
**3700 W. Riverside**  
**Mixed-Use Development**  
 3700 W. RIVERSIDE DR.  
 BURBANK, CA 91505

PREPARED FOR:  
**3700 W. RIVERSIDE**  
**INVESTMENTS, LLC**  
 127 N. MADISON AVE.  
 SUITE 200  
 PASADENA, CALIF 91101

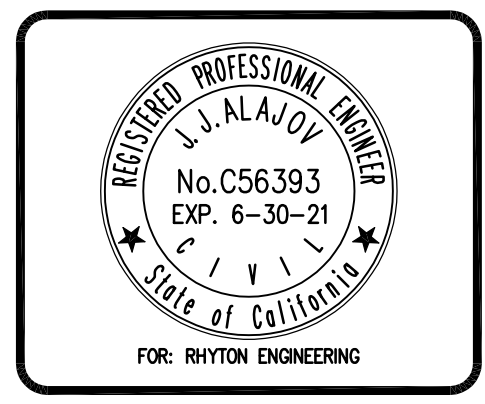

**SUSTAINABLE SITE SOLUTIONS**  
 13361 E. 15th St., Suite 100, Burbank, CA 91502  
 (818) 478-7788 (818) 990-9903 www.RhytonCivil.com

NOT FOR CONSTRUCTION

CUP AND DR SUBMITTAL

SHEET TITLE:  
**ROUGH GRADING & EXCAVATION PLAN**

CHECKED BY:  
 WHR, JJA


PROJECT No:  
 1BAL1004.00

DATE:  
 09/19/2019

SCALE:  
 AS SHOWN

SHEET ID No.  
**C04**

SHEET 2 OF 4

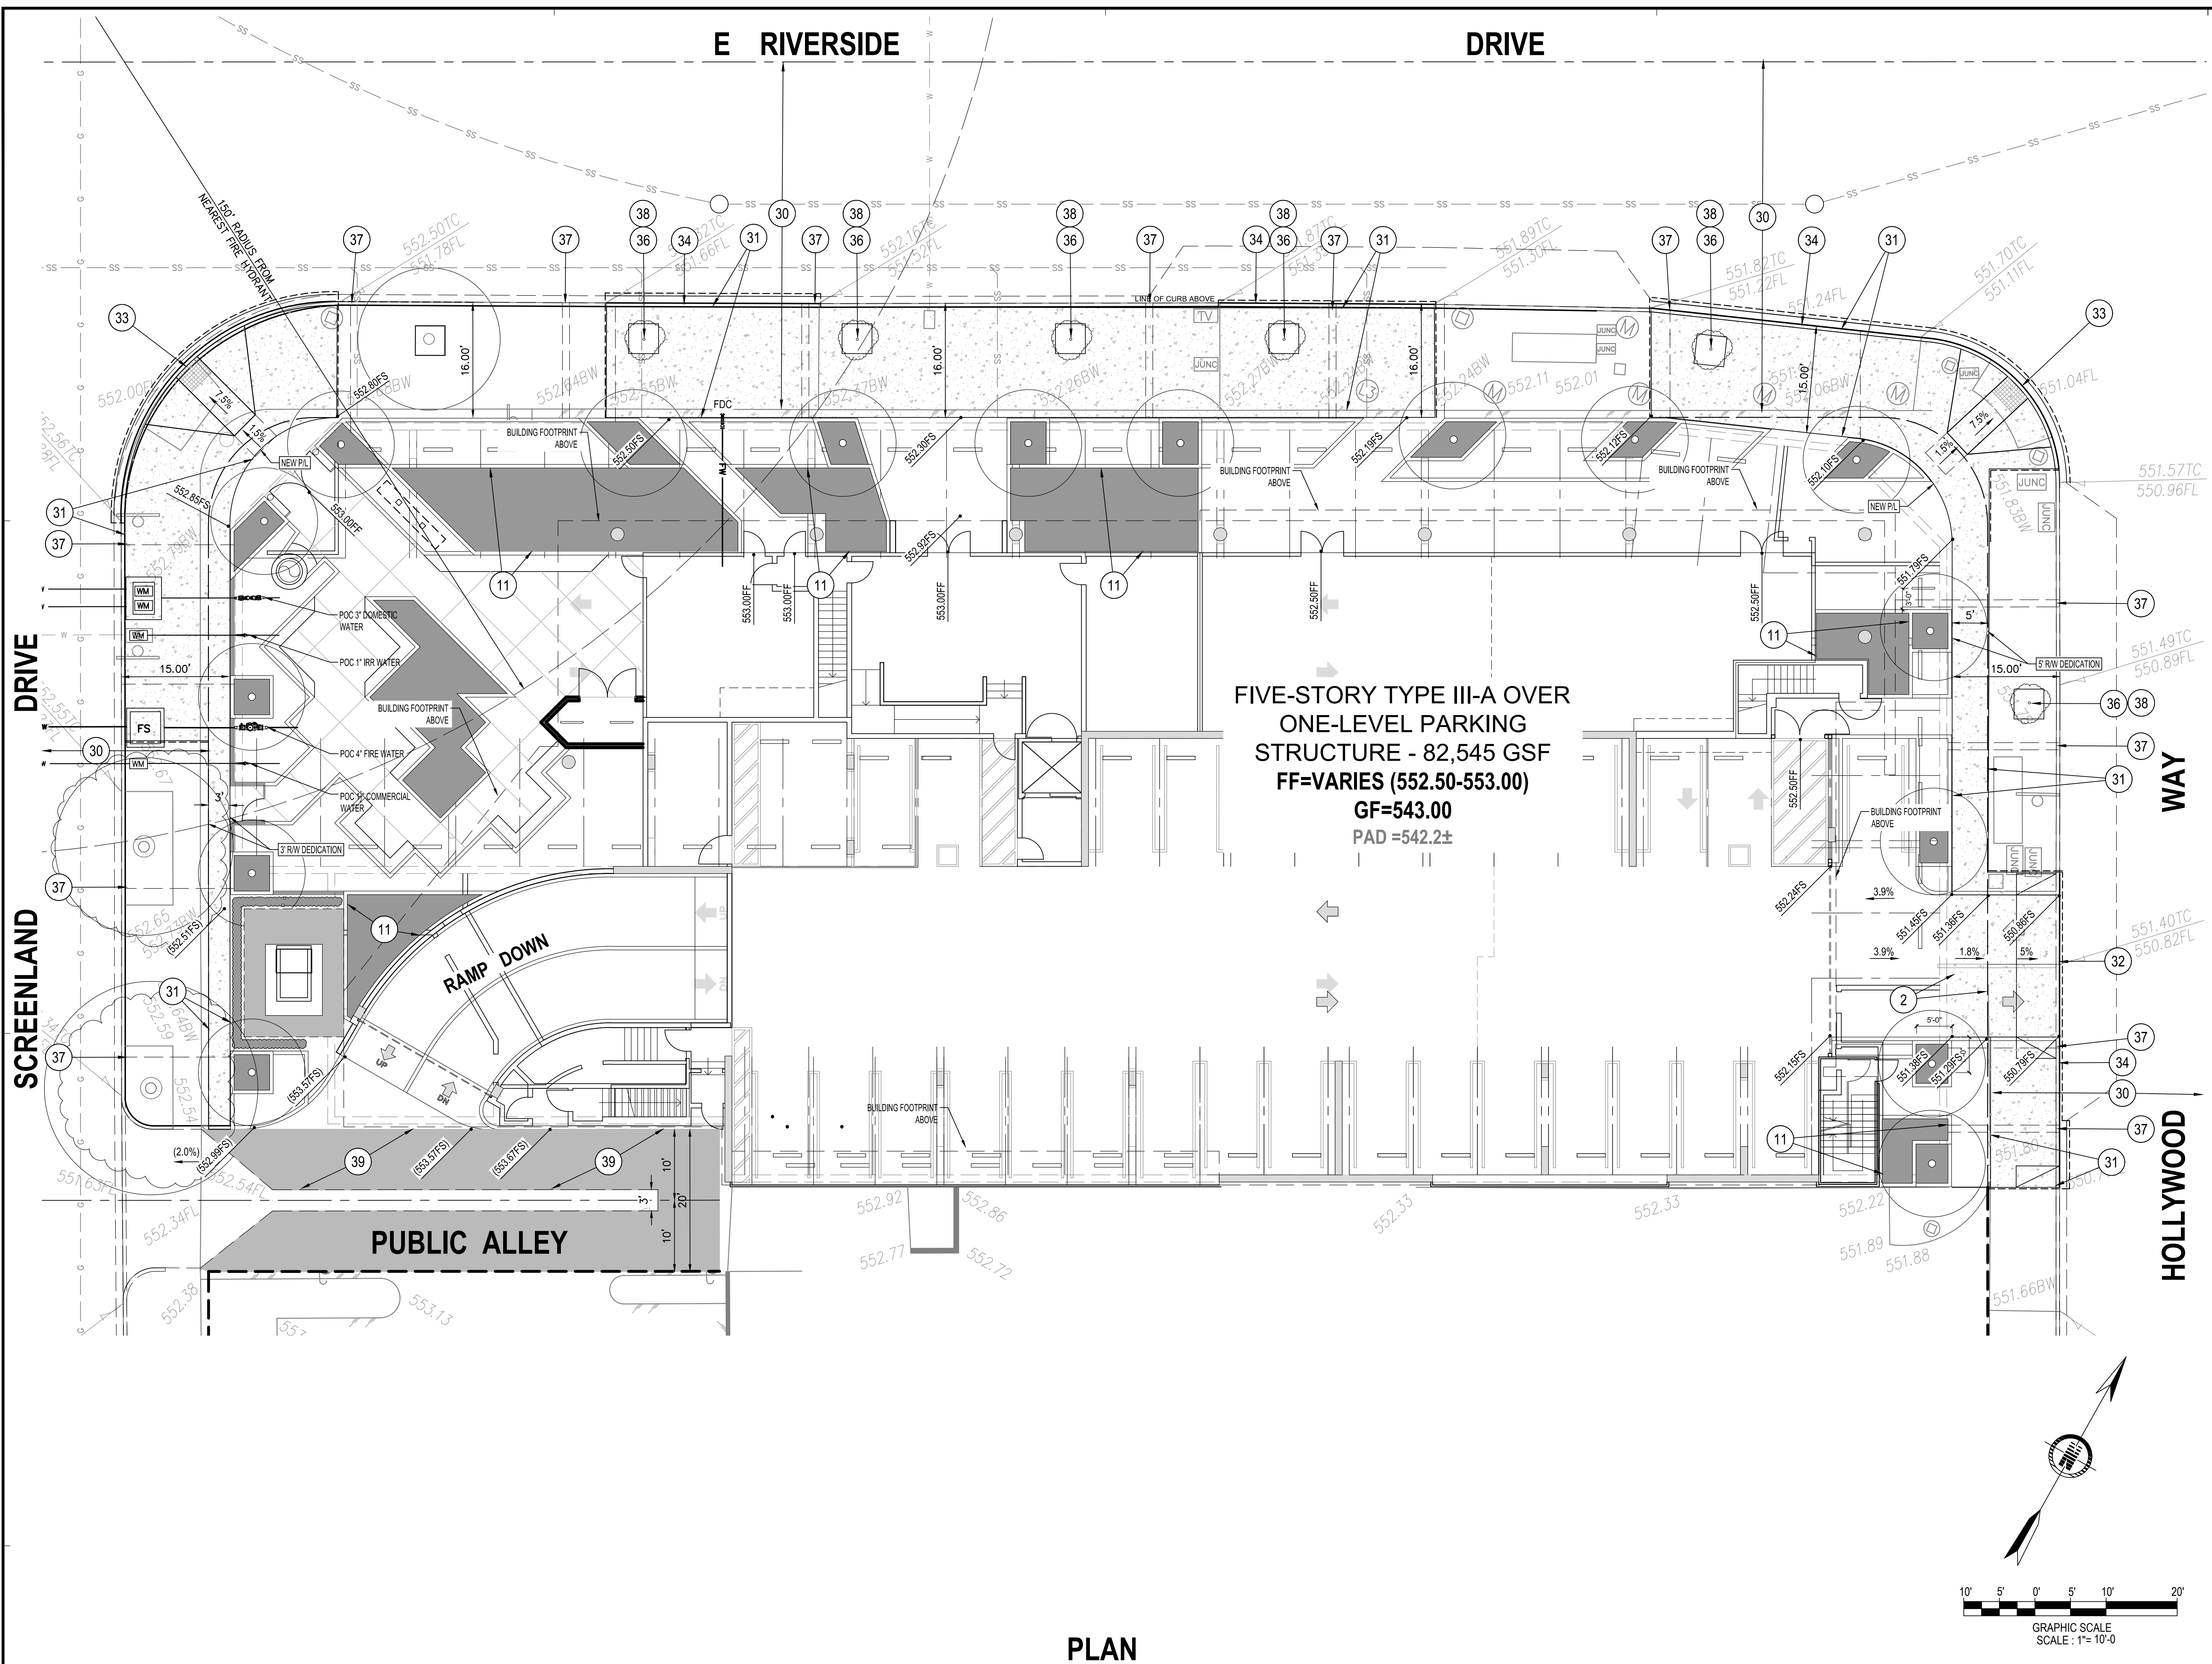

**PLAN**


- LEGEND NOTES**
- LEGEND NOTES ARE COMMON TO ALL SIMILAR PLANS  
SOME NOTES MAY NOT APPLY TO THIS SHEET
- PRECISE GRADING AND DRAINAGE**
- CONSTRUCT A1 (0") CURB ONLY PER BDPW STD. BS-100
  - CONSTRUCT 6" CONCRETE PAVEMENT, OVER 6" MISC. BASE. JOIN FLUSH EXISTING PAVEMENT ALONG SAWCUT & JOIN LINES.
  - GRADE AND PLANT ONLY. SEE LANDSCAPING PLANS FOR DETAILS
  - CONSTRUCT A1-150 (6") CURB ONLY PER BDPW STD. BS-100
  - SAWCUT AND JOIN FLUSH EXISTING PAVEMENTS.
  - INSTALL PERMANENT FENCE AND GATES PER ARCHITECTURAL PLANS
  - CONSTRUCT 4" CONCRETE WALK PER BDPW STD. PLAN BS-104
  - SAWCUT CONTROL JOINTS AND CONSTRUCT EXPANSION JOINTS
  - ADJUST TO GRADE THE RIM, COVER, OR BOX OF EXISTING UNDERGROUND VAULT, CLEANOUT, VALVE COVER, ACCESS HATCH OR PULLBOX.
  - 4" STEEL BOLLARDS, GROUTED SOLID. PAINT EXPOSED SURFACE.
  - CONSTRUCT RAISED "FLOW-THRU" PLANTER FROM REINFORCED CONCRETE OR MASONRY BLOCK (PRECISION BLOCK). WATERPROOF WALLS AND BOTTOM (HOT APPLIED ASPHALT MEMBRANE, PROTECTION COURSE AND DRAIN BOARD, WITH SS-COUNTER FLASHING ON TOP AND N-FLASHING AT BOTTOM CORNERS) AND INSTALL MEDIA, PLANTS, MULCH, SUB-DRAIN AND OVERFLOW DRAINS AND DRAIN THRU STREET CURB.
  - CONSTRUCT CURB TRANSITION FROM 0" CURB FACE TO 6" CURB FACE.
  - CONSTRUCT RAISED PLANTER OUTLET DRAIN. CORE THROUGH WALL AND SPILL PIPE ONTO STREET GUTTER SURFACE.
  - CONSTRUCT TRENCH DRAIN
- PUBLIC STREET IMPROVEMENTS**
- PUBLIC IMPROVEMENTS TO BE CONSTRUCTED PER SEPARATE PERMIT FROM DEPARTMENT OF PUBLIC WORKS. CONTRACTOR TO OBTAIN
  - REMOVE AND REPLACE (E) SIDEWALK AND/OR DRIVEWAY (TO THE NEAREST EXISTING JOINT), WITH 3" MIN CONC. SIDEWALK PER BDPW STD. BS-104.
  - CONSTRUCT NEW CONC. DRIVEWAY APPROACH (CURB-CUT) PER BDPW STD. BS-103, TYPE 2; W; X; AND Y. PER PLAN. 1-6" MIN.
  - CONSTRUCT NEW CURB ACCESS RAMP AND INSTALL DETECTABLE WARNINGS (TRUNCATED DOMES) PER CALTRANS REVISED STD. PLAN 888A. SEE NOTE '8' FOR GUTTER SLOPE AND REMOVE AND RECONSTRUCT PORTION OF CURB AT BOTTOM OF (E) RAMP, IF NOT FLUSH WITH (E) CONC. GUTTER.
  - CONSTRUCT A2-200 (8") CURB AND GUTTER (BARRIER) PER BDPW STD. BS-100. MATCH WIDTH OF EXISTING GUTTER AND JOIN FLUSH. IF REQUIRED, REPLACE PORTION OF (E) AC PAVEMENT ALONG THE EDGE OF GUTTER.
  - BACKFILL UTILITIES CONSTRUCTION TRENCH AND REPLACE PORTION OF (E) AC PAVEMENT
  - INSTALL STREET TREE IN A 4'-2" x 4'-2" TREE WELL PER SPPWC STD. PLAN 519-3. TREE SPECIE AND WELL COVER TYPE SHALL BE APPROVED BY CITY OF BURBANK, URBAN FORESTRY DIVISION.
  - CONSTRUCT CURB DRAIN No.1 PER BDPW STD. BS-107.
  - CONTRACTOR TO COORDINATE AND INSTALL PARKWAY TREE WELL COVER TYPE AND SIZE WITH CITY OF BURBANK URBAN FORESTRY
  - CONSTRUCT 6" ASPHALT PAVEMENT OVER 7" AGGREGATE BASE
- GENERAL NOTE:** ALL DRAIN INLETS 12" AND LARGER SHALL BE ACCESSIBLE FOR INSPECTION AND MAINTENANCE AND SHALL BEAR A "NO DUMPING - DRAINS TO OCEAN" SYMBOL, EITHER STENCILED OR AFFIXED NEAR THE STORM DRAIN INLET.

**REVISION INFORMATION**

No.	Date	Revision
1	09/12/2019	CUP AND DR SUBMITTAL
2	09/12/2019	CUP & DR - PLAN UPDATES

**PROJECT NAME:**  
3700 W. Riverside  
Mixed-Use Development  
3700 W. RIVERSIDE DR  
BURBANK, CA 91505

**PREPARED FOR:**  
3700 W. RIVERSIDE  
INVESTMENTS, LLC  
127 N. MADISON AVE.  
SUITE 200  
PASADENA, CALIF 91101

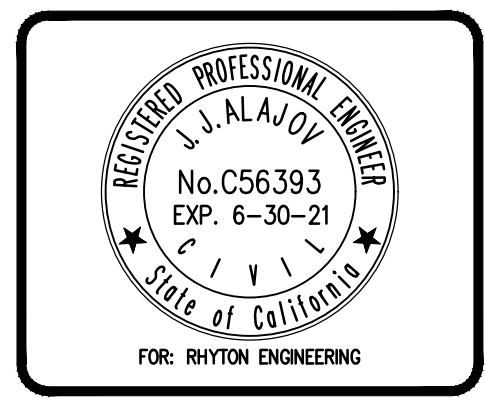

**SUSTAINABLE SITE SOLUTIONS**  
13051 E. 15th Street, Suite 101, 4623  
(818) 478-7788 (818) 960-9803 P. www.SustainableSite.com

DATE: \_\_\_\_\_  
RCE 95983

**ACCESSIBILITY NOTES:**

- CALIFORNIA ACCESS COMPLIANCE, TITLE 24 CCR**
- WALKS AND SIDEWALK SURFACE CROSS SLOPES SHALL NOT EXCEED 1:48 (2.083% GRADIENT) (SEC. 11B-403.3)
  - WHEN THE SLOPE IN THE DIRECTION OF TRAVEL OF ANY WALK EXCEEDS 1:20 (5% GRADIENT) IT SHALL COMPLY WITH THE PROVISIONS OF SECTION 11B-405 AS A PEDESTRIAN RAMP (SEC. 11B-401.1)
  - WALK AND SIDEWALK SURFACES WITH A SLOPE OF LESS THAN 6% GRADIENT SHALL BE AT LEAST AS SLIP-RESISTANT AS THAT DESCRIBED AS A MEDIUM SALTED FINISH. (SEC. 11B-403.2)
  - WALK & SIDEWALK SURFACES WITH A SLOPE OF 6% OR MORE GRADIENT SHALL BE SLIP-RESISTANT. (SEC. 11B-403.2)
  - ALL WALKS WITH CONTINUOUS GRADIENTS SHALL HAVE LEVEL AREAS AT LEAST 5' IN LENGTH AT INTERVALS OF AT LEAST EVERY 400'. (SEC. 11B-403.7)
  - WALKS SHALL BE PROVIDED WITH A LEVEL AREA NOT LESS THAN 60"x60" AT A DOOR OR GATE THAT SWINGS TOWARD THE WALK, AND NOT LESS THAN 48" WIDE x 44" DEEP AT A DOOR OR GATE THAT SWINGS AWAY FROM THE WALK. (SEC. 11B-403.7)
  - WALKS AND SIDEWALKS SHALL HAVE A CONTINUOUS COMMON SURFACE, NOT INTERRUPTED BY STEPS OR BY ABRUPT CHANGES IN LEVEL EXCEEDING 1/2", AND SHALL BE A MINIMUM OF 48" WIDE. (SEC. 11B-403.1)
  - WHEN ABRUPT CHANGES IN LEVEL NOT EXCEEDING 1/2" OCCUR, THEY SHALL BE BEVELED WITH A SLOPE NO GREATER THAN 1 UNIT VERTICAL TO 2 UNITS HORIZONTAL (50%), EXCEPT THAT LEVEL CHANGES NOT EXCEEDING 1/4" MAY BE VERTICAL. (SEC. 11B-403.4 AND FIGURES 11B-5E (c) AND (d))
  - ABRUPT CHANGES IN LEVEL ALONG ANY ACCESSIBLE ROUTE EXCEEDING 1/2" SHALL COMPLY WITH THE REQUIREMENTS FOR CURB RAMPS. (SEC. 11B-403.4)
  - WALKS SHALL EXTEND A MINIMUM OF 24" TO THE SIDE OF THE STRIKE EDGE OF A DOOR OR GATE THAT SWINGS TOWARD THE WALL. (SEC. 11B-403.7)
  - WALKS, SIDEWALKS, AND PEDESTRIAN WAYS SHALL BE FREE OF GRATINGS WHEREVER POSSIBLE. GRID OPENINGS IN GRATINGS SHALL BE 1/2" WIDE MAX IN THE DIRECTION OF TRAFFIC FLOW. ELONGATED OPENINGS, IF PROVIDED SHALL BE PLACED SO THAT THE LONG DIMENSION IS PERPENDICULAR TO THE DOMINANT DIRECTION OF TRAVEL. (SEC. 1023.2 AND FIG. 11B-7B (a) AND 11B-302.3)
  - ABRUPT CHANGES IN LEVEL, 4" OR MORE, EXCEPT BETWEEN A WALK OR A SIDEWALK AND ADJACENT STREETS OR DRIVEWAYS SHALL BE IDENTIFIED BY A 6" HIGH CURBS ABOVE WALK SURFACE. (SEC. 11B-303.5)
  - PROVIDE SIGNS DISPLAYING THE INTERNATIONAL SYMBOL OF ACCESSIBILITY AT EVERY PRIMARY PUBLIC ENTRANCE AND AT EVERY MAJOR JUNCTION ALONG OR LEADING TO AN ACCESSIBLE ROUTE OF TRAVEL. SIGNS SHALL INDICATE THE DIRECTION TO ACCESSIBLE BUILDING ENTRANCES AND SHALL COMPLY WITH SECTION 11B-703 (SEC. 11B-216.6)
  - HANDRAILS, STAIRWAYS SHALL HAVE HANDRAILS AT BOTH SIDES OF ALL STAIRS. HANDRAILS SHALL HAVE THE FOLLOWING FEATURES:
    - HANDRAILS SHALL BE CONTINUOUS ALONG BOTH SIDES OF STAIRS.
    - IF HANDRAILS ARE NOT CONTINUOUS, THEY SHALL EXTEND AT LEAST 12 IN (305 MM) BEYOND THE TOP RISER AND AT LEAST 12 IN (305 MM) PLUS THE WIDTH OF ONE TREAD BEYOND THE BOTTOM RISER. AT THE TOP, THE EXTENSION SHALL BE PARALLEL WITH THE GROUND SURFACE. AT THE BOTTOM, THE HANDRAIL SHALL CONTINUE TO SLOPE FOR A DISTANCE OF THE WIDTH OF ONE TREAD FROM THE BOTTOM RISER; THE REMAINDER OF THE EXTENSION SHALL BE HORIZONTAL.
    - THE CLEAR SPACE BETWEEN HANDRAILS AND WALL SHALL BE 1-1/2 IN.
    - GRIPPING SURFACES SHALL BE UNINTERRUPTED BY NEWEL POSTS, OTHER CONSTRUCTION ELEMENTS, OR OBSTRUCTIONS.
    - TOP OF HANDRAIL GRIPPING SURFACE SHALL BE MOUNTED BETWEEN 34 IN AND 38 IN ABOVE STAIR NOSINGS. (SEC. 11B-505.4)
    - ENDS OF HANDRAILS SHALL BE EITHER ROUNDED OR RETURNED SMOOTHLY TO GROUND, WALL OR POST.
    - HANDRAILS SHALL NOT ROTATE WITHIN THEIR FITTINGS.
    - 12" EXTENSION IS MEASURED TO THE INSIDE OF THE ROUNDED OR RETURNED PART OF THE HANDRAIL TO PROVIDE ROOM FOR A HAND GRIP.

**LEGEND:**

- |                     |                               |  |  |
|---------------------|-------------------------------|--|--|
| — 415 —             | PROPOSED CONTOUR              |  |  |
| - - - 410.50 - - -  | PROPOSED HALF CONTOUR         |  |  |
| — 414 —             | EXISTING TOPO CONTOUR         |  |  |
| ▲ 415.90 F.S        | PROPOSED SPOT ELEVATION       |  |  |
| ▲ (415.88 F.S) JOIN | JOIN SPOT ELEVATION           |  |  |
| ▲ 415.90 F.S        | EXISTING TOPO ELEVATION       |  |  |
| — SD —              | RETAINING WALL/SITE WALL      |  |  |
| - - - - -           | STORM DRAIN                   |  |  |
| — · — · —           | SIDEWALK CULVERT / PARK DRAIN |  |  |
| — · — · —           | FLOW LINE                     |  |  |
- 
- |  |                                      |
|--|--------------------------------------|
|  | P.C.C. PAVEMENT                      |
|  | A.C. PAVEMENT                        |
|  | PLANTER AREA                         |
|  | ENHANCED PAVEMENT (PERMEABLE PAVERS) |
|  | ADA COMPLIANT PATH OF TRAVEL         |

**NOTICE TO CONTRACTORS:**

- THE CONTRACTOR SHALL FIELD VERIFY ALL FINISHED FLOOR ELEVATIONS AT THE ENTRANCES OF THE EXISTING ONE STORY BUILDING AND EXISTING PAVEMENT JOIN ELEVATIONS ALONG THE PERIMETER OF THE PROJECT, AND INFORM ENGINEER FOR ANY DISCREPANCIES. PRIOR TO PROCEEDING WITH CONSTRUCTION.
- THE CONTRACTOR IS RESPONSIBLE FOR PULLING A PERMIT FROM THE CITY TO PERFORM ALL OFF-SITE CIVIL AND RELATED WORK. IT SHOULD BE MADE CLEAR THAT PART OF THAT PROCESS WILL REQUIRE THE CONTRACTOR TO PROVIDE A TRAFFIC CONTROL PLAN TO SATISFY CITY OF LOS ANGELES REQUIREMENTS AND INCLUDE THE COSTS OF TEMPORARY TRAFFIC CONTROL REQUIRED BY THE CITY OF LOS ANGELES TO ACCOMPLISH WORK UNDER CITY PERMITS.


**NOT FOR CONSTRUCTION**



**CUP AND DR SUBMITTAL**

**PRECISE GRADING & DRAINAGE PLAN**

CHECKED BY: WHR, JJA  
PROJECT NO: 18AL1004.00  
DATE: 09/19/2019  
SCALE: AS SHOWN  
SHEET ID NO: C05  
SHEET 3 OF 4

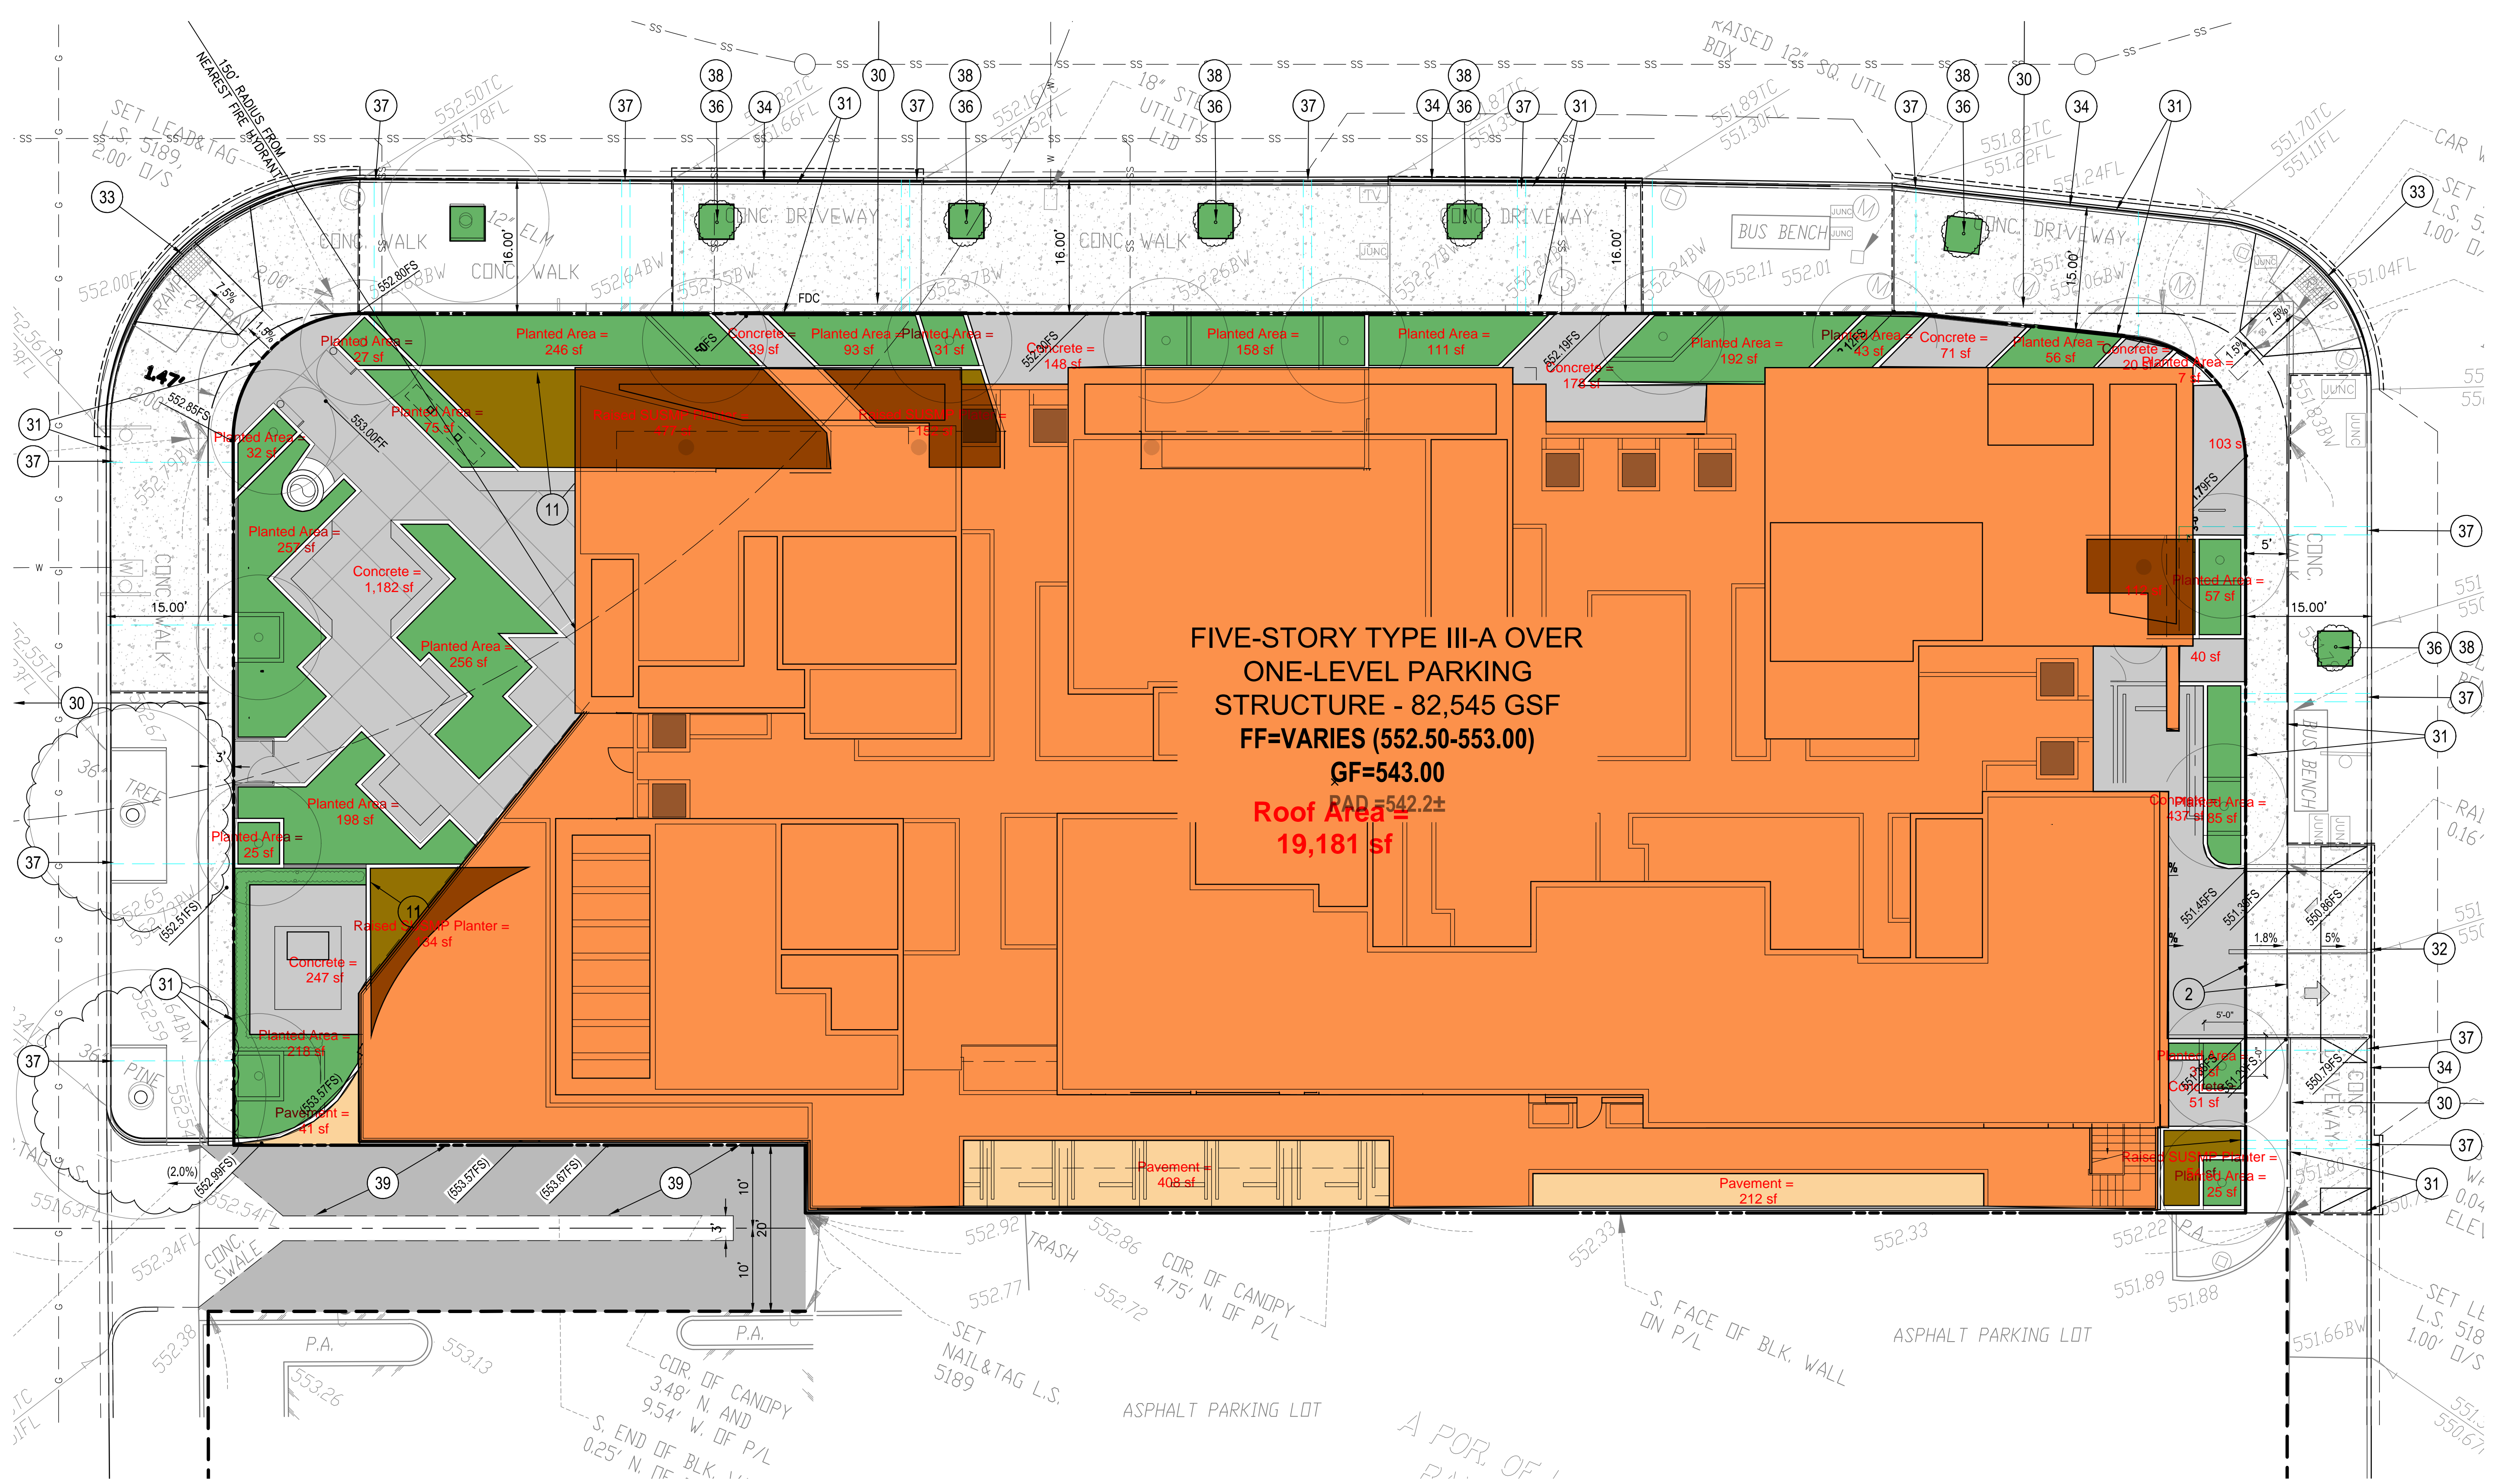

**LEGEND NOTES**

LEGEND NOTES ARE COMMON TO ALL SIMILAR PLANS SOME NOTES MAY NOT APPLY TO THIS SHEET

	PROPOSED STORM DRAIN
	EXISTING STORM DRAIN
	PERMEABLE SURFACE (LANDSCAPING)
	PERMEABLE SURFACE (PAVERS OR POROUS)
	IMPERMEABLE SURFACE (ROOFING)
	IMPERMEABLE SURFACE (PAVEMENT)
	DIRECTION OF STORMWATER FLOW
	ROOF DOWNSPOUT ROUTED TO STORM DRAIN
	RAISED "FLOW-THRU" FILTERING PLANTER
	FILTERING DRAIN INLET INSERT "TRITON" O.A.E.

**NO DUMPING  
DRAINS TO OCEAN**

"NO DUMPING - DRAINS TO OCEAN" SYMBOL STENCILS ARE AVAILABLE AT THE LOCAL BUILDINGS AND SAFETY OFFICE. THERMOPLASTIC SIGNS CAN BE ORDERED FROM "SAFE USA" AT (909) 983-0703; WWW.ROADFIX.COM

**REVISION INFORMATION**

No.	Date	Revision
1	09/12/2019	CUP AND DR SUBMITTAL
2	09/12/2019	CUP & DR - PLAN UPDATES




PROJECT NAME:  
**3700 W. Riverside  
Mixed-Use Development**  
3700 W. RIVERSIDE DR  
BURBANK, CA 91505

PREPARED FOR:  
**3700 W. RIVERSIDE  
INVESTMENTS, LLC**  
127 N. MADISON AVE.  
SUITE 200  
PASADENA, CALIF 91101



**SUSTAINABLE SITE SOLUTIONS**  
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(818) 478-7788 (818) 980-9803 www.StyfonCivil.com

DATE: RCE 95893  
Prepared by: William Reany W

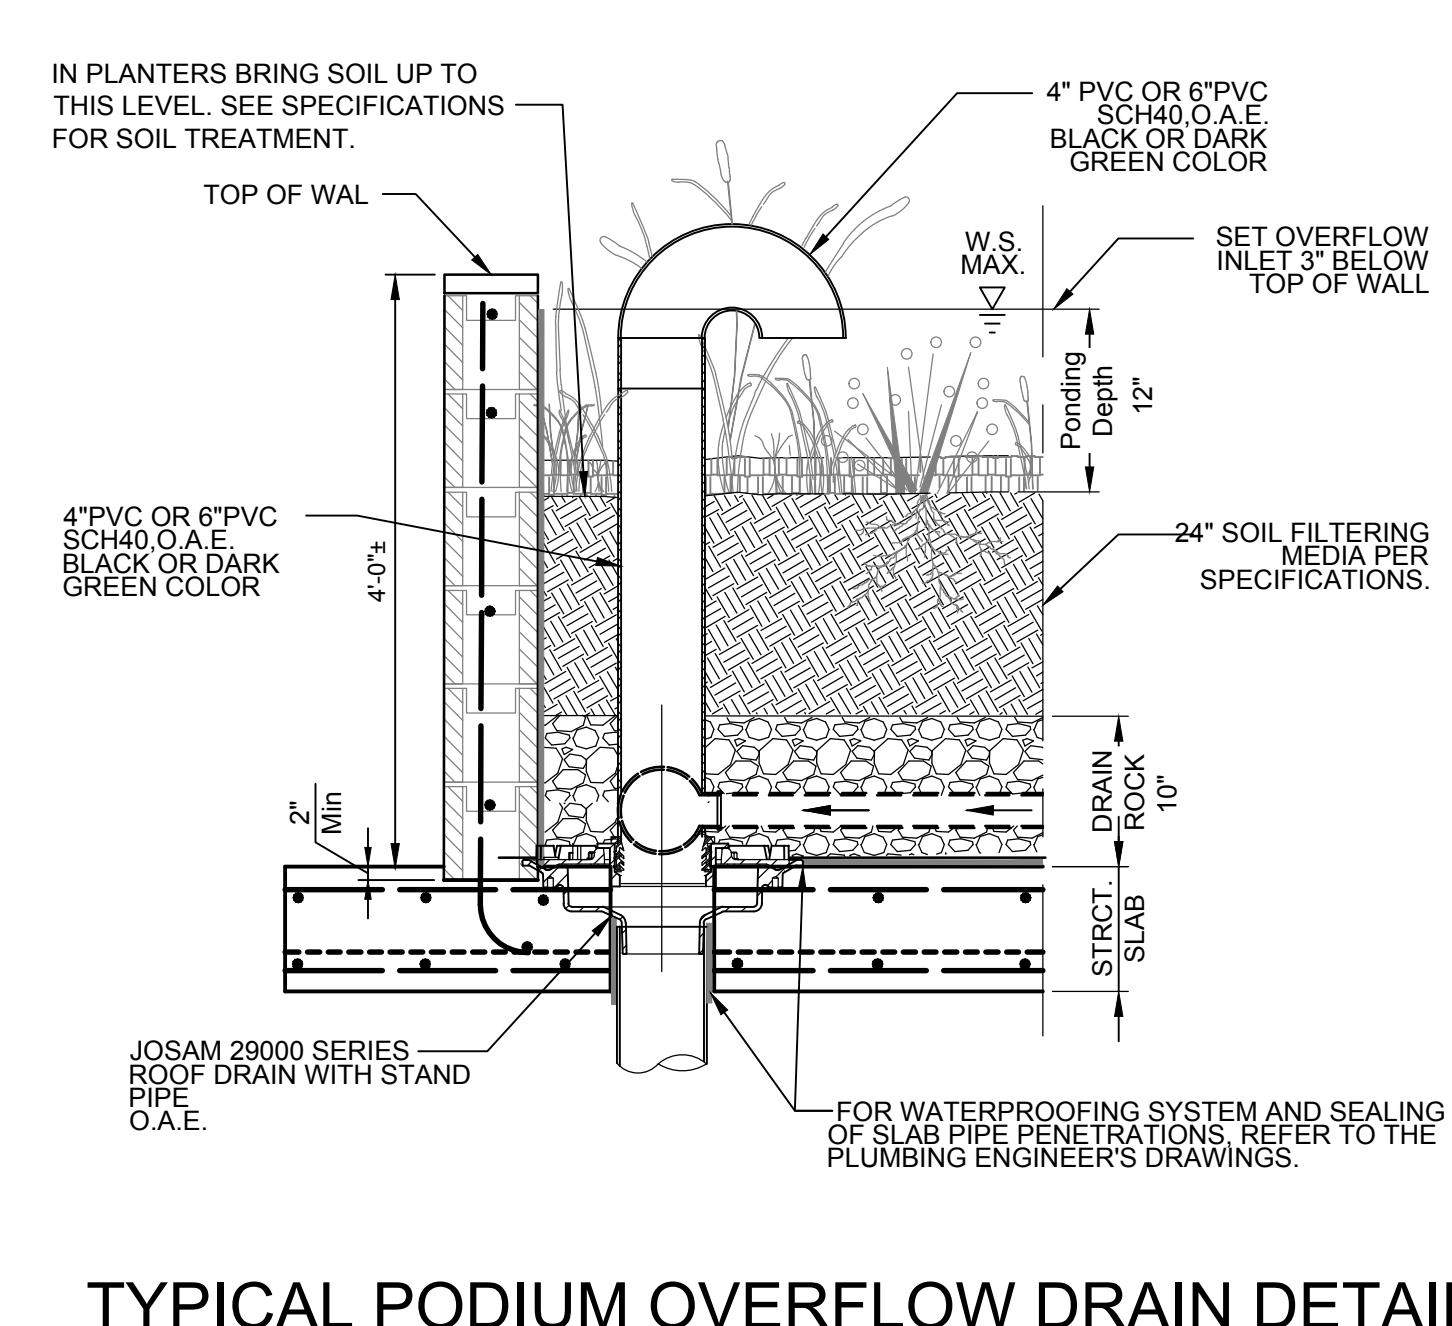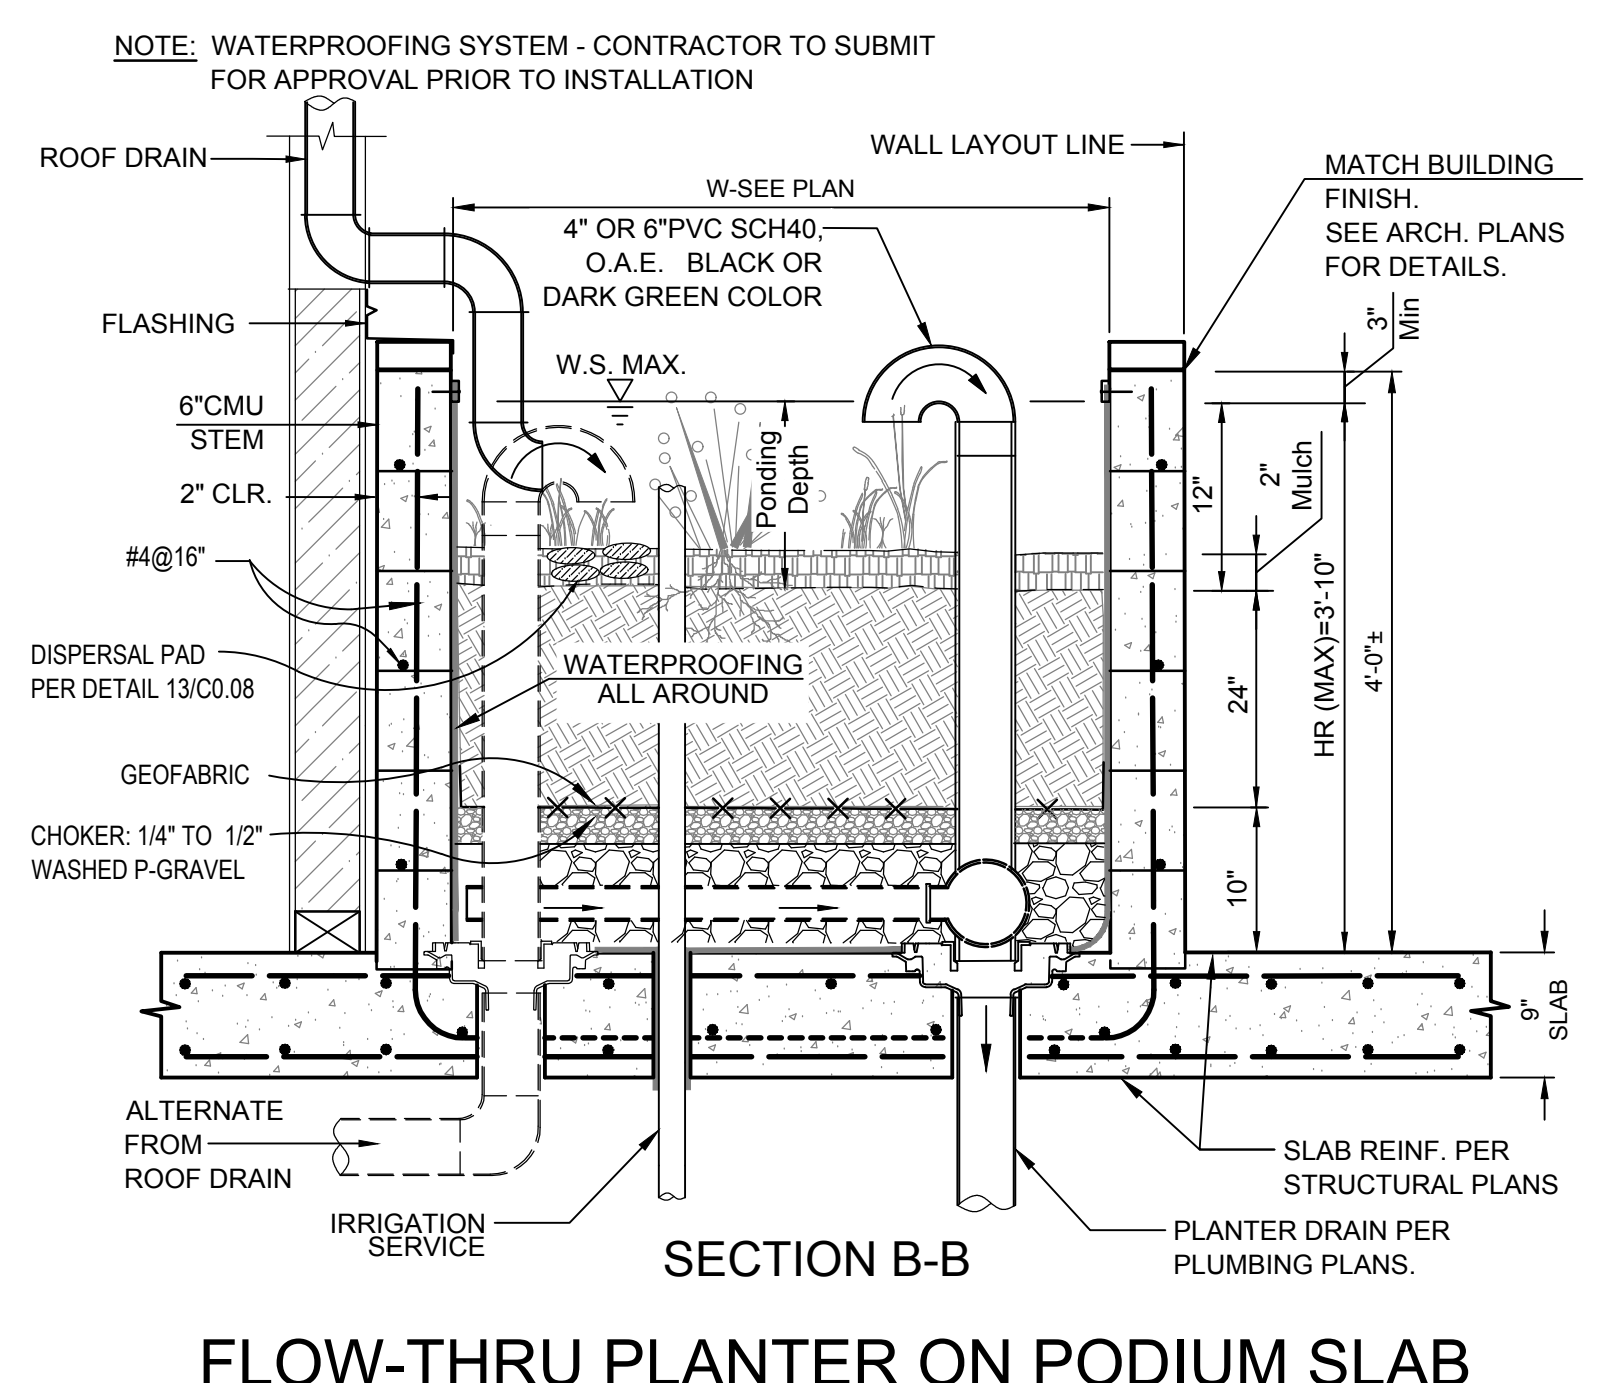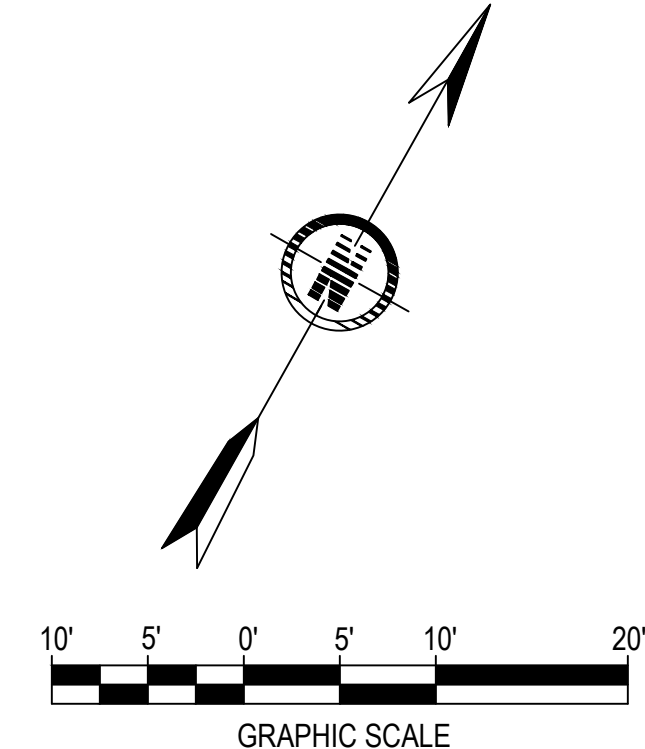

CUP AND DR SUBMITTAL

SHEET TITLE:  
**SUSMP  
EXHIBIT**

CHECKED BY:  
WHR, JJA

PROJECT NO:  
1BAL1004.00

DATE:  
09/19/2019

SCALE:  
AS SHOWN

SHEET ID NO:  
**C07**

SHEET 4 OF 4




















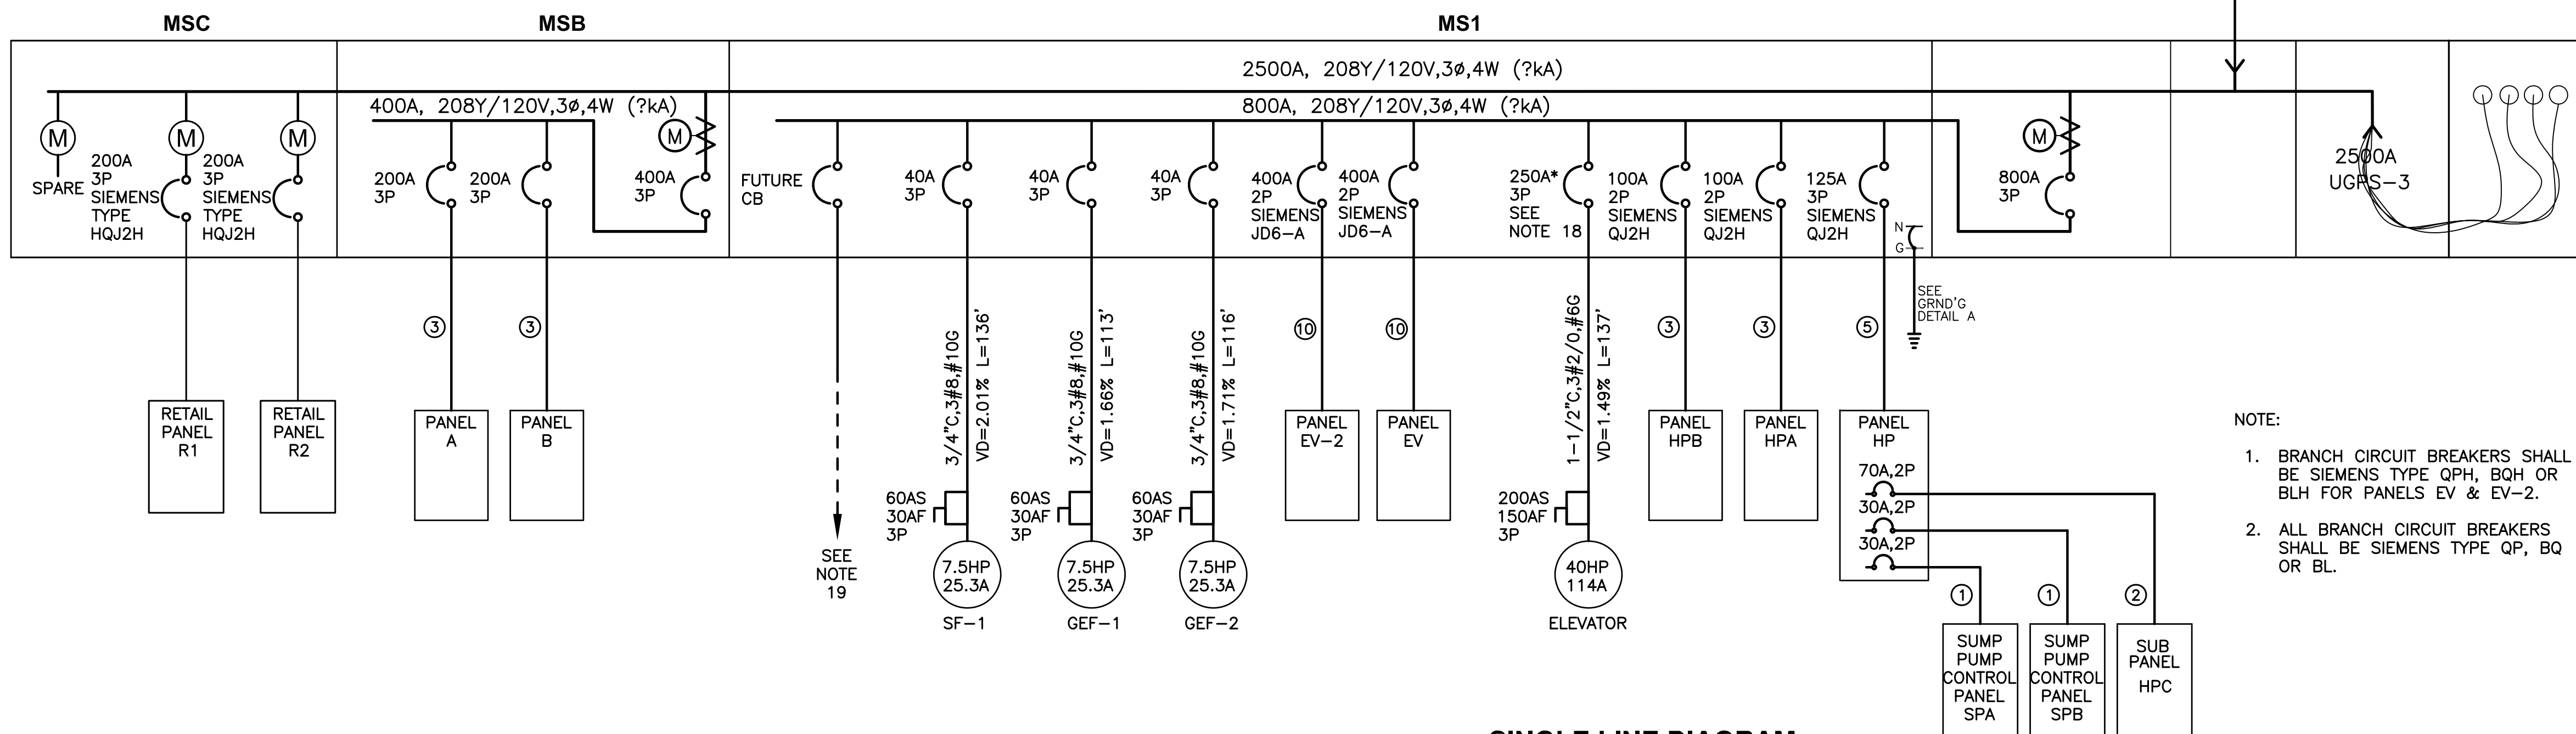

- NOTE:
- BRANCH CIRCUIT BREAKERS SHALL BE SIEMENS TYPE QPH, BOH OR BLH FOR PANELS EV & EV-2.
  - ALL BRANCH CIRCUIT BREAKERS SHALL BE SIEMENS TYPE QP, BQ OR BL.

**1 SINGLE LINE DIAGRAM**  
SCALE: NONE

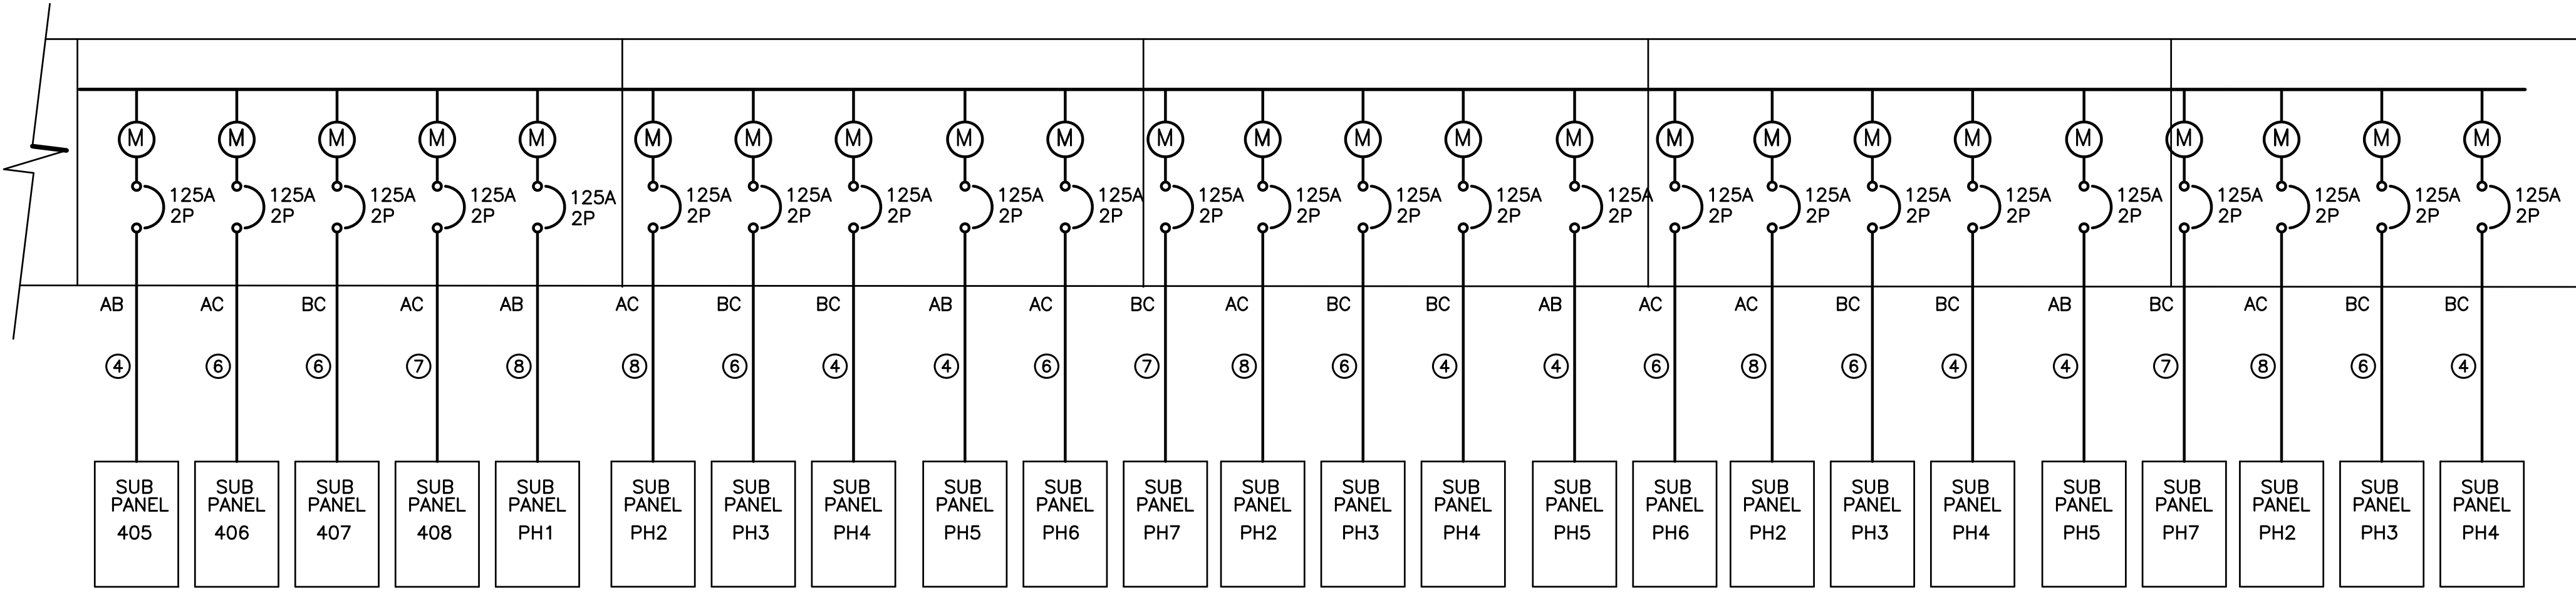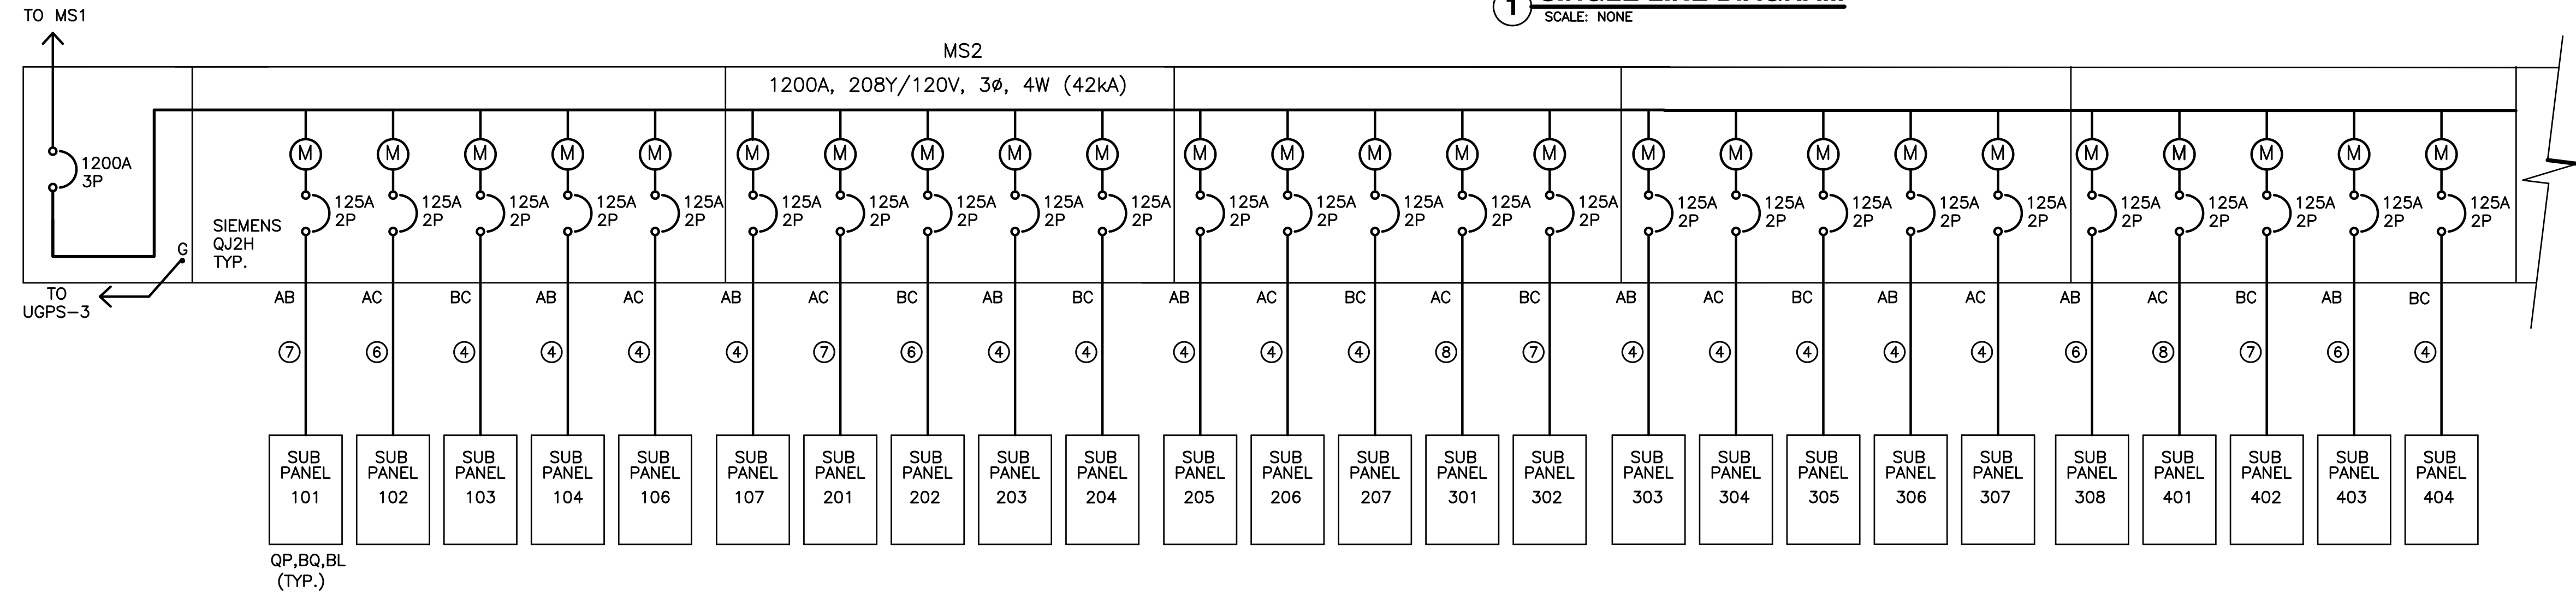


- SINGLE LINE DIAGRAM NOTES:
- ALL WORK SHALL BE PERFORMED PER 2013 CALIFORNIA ELECTRICAL CODE.
  - ALL ELECTRICAL EQUIPMENT AND SWITCHBOARDS SHALL BE FULLY RATED.
  - ALL ELECTRICAL EQUIPMENT AND SWITCHBOARDS SHALL BE SERIES RATED.
  - PROVIDE A CAUTIONARY LABEL TO THE SERIES RATED DEVICE COVER STATING "CAUTION-SERIES COMBINATION SYSTEM RATED 42,000VA. IDENTIFIED REPLACEMENT COMPONENTS REQUIRED".
  - ALL ELECTRICAL EQUIPMENT, SWITCHBOARDS, ETC. TO WITHSTAND AVAILABLE FAULT CURRENT. VERIFY WITH SERVING UTILITY COMPANY.
  - ELECTRICAL EQUIPMENT SHALL BE LISTED BY A CITY OF LOS ANGELES RECOGNIZED ELECTRICAL TESTING LABORATORY OR UL.
  - PROVIDE SEISMIC BRACING FOR ALL SERVICE EQUIPMENT, SWITCHBOARDS AND OTHER FLOOR STANDING EQUIPMENT BY INSTALLING APPROVED ANCHORS TO THE BUILDING STRUCTURE FROM EACH EQUIPMENT ENCLOSURE.
  - FURNISH ELECTRICAL EQUIPMENT OF THE SAME TYPE OR CLASS FROM ONE MANUFACTURER.
  - EQUIP ALL DISTRIBUTION FUSIBLE SWITCHES WITH REJECTION TYPE FUSE CLIPS FOR USE WITH CURRENT LIMITING, U.L. CLASS "R" FUSES.
  - PROVIDE FUSES FROM ONE MANUFACTURER OF THE FOLLOWING TYPES:
    - "RK-1" - U.L. CLASS "RK-1" CURRENT LIMITING FUSES, "BUSSMANN" LOW-PEAK TYPE LPN-RK-SP.
    - "RK-2" - U.L. CLASS "RK-2" CURRENT LIMITING, DUAL ELEMENT FUSES, "BUSSMANN" LOW-PEAK TYPE LPN-RK-SP.
  - ALL CONDUCTORS SHALL BE COPPER WITH TYPE "THWN/THHN" INSULATION RATED FOR 600 VOLTS.
  - FEEDER LENGTHS NOTED ON DRAWINGS ARE FOR VOLTAGE DROP AND SHORT CIRCUIT CALCULATIONS ONLY AND ARE NOT TO BE USED FOR ESTIMATE OR MATERIAL TAKE-OFF.
  - NO PIPING, DUCTS OR EQUIPMENT FOREIGN TO ELECTRICAL EQUIPMENT SHALL BE PERMITTED TO BE LOCATED WITHIN THE DESIGNATED SPACE.
  - ALL TERMINALS/LUGS SHALL BE DUAL RATED 60/75" C.
  - THE ELECTRICAL ROOM DOOR SHALL OPEN OUTWARD AND SHALL BE EQUIPPED WITH PANIC HARDWARE.
  - THE GROUNDING CONDUCTOR SHALL BE CONNECTED TO WATER PIPE (GROUNDING ELECTRODE) WITHIN 5' FROM THE POINT OF ENTRANCE INTO THE BUILDING.
  - PROVIDE SEISMIC ANCHORING AND BRACING FOR MAIN SWITCHBOARD AND ALL STANDING SECTIONS.
  - ELEVATOR CIRCUIT BREAKER SHALL BE EQUIPPED W/ SHUNT TRIP (SIEMENS C/B TYPE FXDS OR EQ.)
  - INSTALL A 1" CONDUIT FROM THE MAIN SWITCHBOARD TO THE ROOF AND TERMINATE IN A 12"x12"x6" NEMA 3R BOX FOR FUTURE SOLAR. THE CONDUIT FOR THE FUTURE ELECTRICAL SOLAR SYSTEM SHALL BE LABELED AS PER LOS ANGELES FIRE DEPARTMENT REQUIREMENTS.
  - CIRCUIT BREAKERS USED AS SWITCHES IN 120 AND 277 VOLT FLUORESCENT LIGHTING CIRCUITS SHALL BE LISTED AND MARKED AS "SWD" OR "HID".
  - PROVIDE A LABEL STATING "EV CAPABLE" IS A CONSPICUOUS PLACE AT THE SERVICE PANEL OR SUBPANEL AND NEXT TO THE RACEWAY TERMINATION POINT.
  - CONDUCTORS OF A MULTI-WIRE BRANCH CIRCUIT SHALL CONSPICUOUSLY ORIGINATE FROM THE SAME PANELBOARD. THE BRANCH CIRCUIT SHALL BE PROVIDED WITH A MEANS THAT WILL SIMULTANEOUSLY DISCONNECT ALL UNGROUNDED CONDUCTORS AT THE POINT WHERE THE BRANCH CIRCUIT ORIGINATES (210.4, 240.15(B)(1)).
  - ANY CONDUIT RUN OR MULTICONDUCTOR CABLE LEAVING THE CLASS 1, DIVISION 1 OR CLASS 1, DIVISION 2 LOCATION SHALL BE PROVIDED WITH A CONDUIT OR CABLE SEAL. THE CABLE SEAL SHALL BE INCAPABLE OF TRANSMITTING GASES OR VAPORS THROUGH THE CABLE CORE. THE SEAL SHALL BE INSTALLED ON EITHER SIDE WITHIN 10 FEET OF THE SPECIFIED HAZARDOUS AREA BOUNDARY, UNLESS SHORTER DISTANCE IS REQUIRED BY METHANE STANDARD. (501.15(A)(4),(B)(2),(D)(3)).
  - EACH ELECTRICAL SERVICE SHALL HAVE PERMANENTLY INSTALLED USER-ACCESSIBLE METERING OF TOTAL ELECTRICAL ENERGY USE PER TABLE 130.5(A)

SERVICE SIZE	M.B.J. SIZE
0-1000 A	# 3/0
1200 A	# 4/0
1600 A	250 MCM
2000 A	300 MCM
2500 A	500 MCM
3000 A	500 MCM
4000 A	600 MCM

Service Size	O.E.C. Size
0-200 A	#4
201-400 A	#1/0
Over 401 A	#3/0

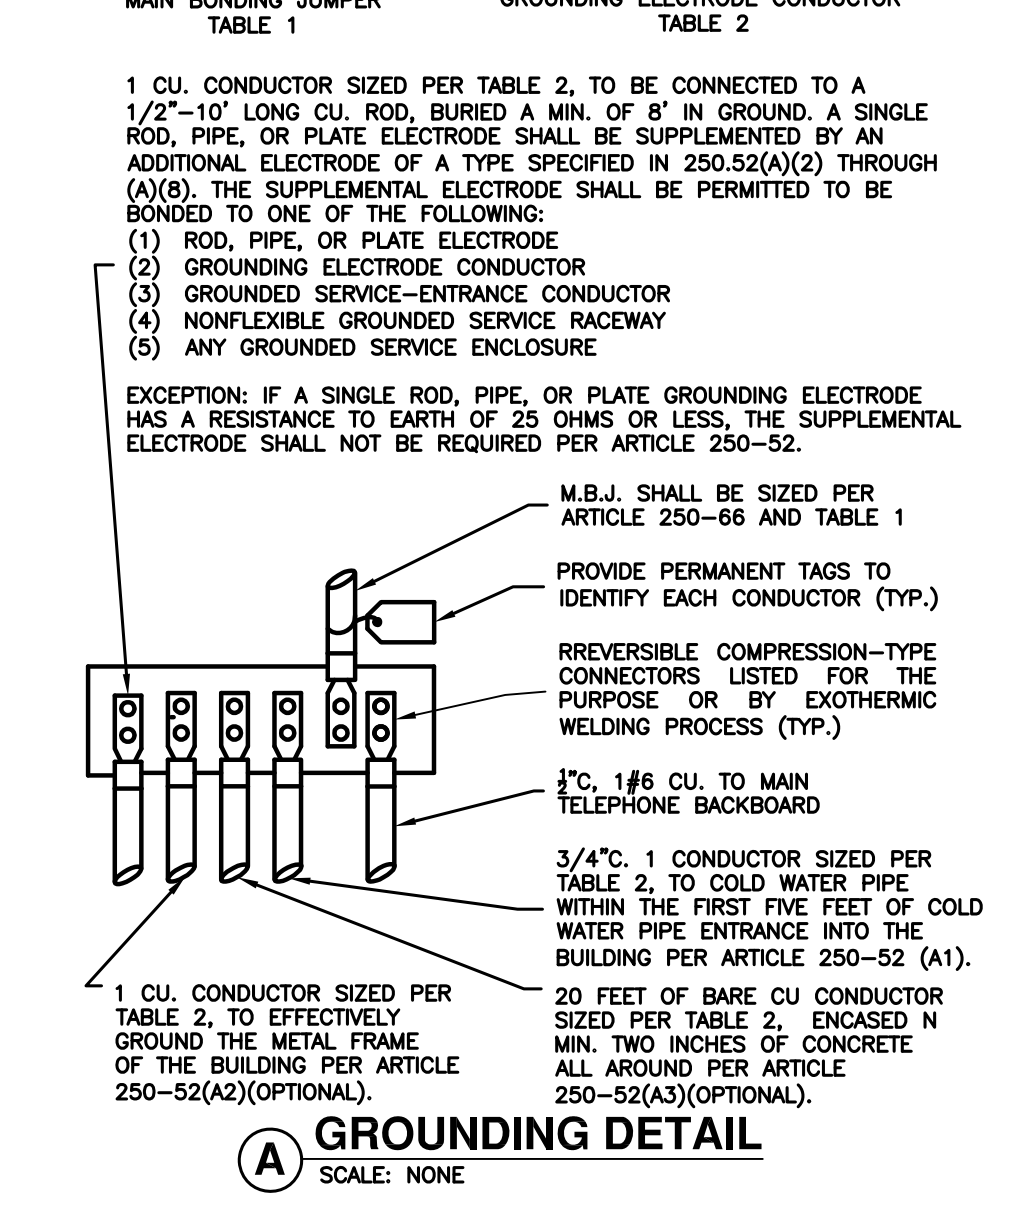

ID	CONDUIT AND FEEDER	FEEDING THESE DEVICES
①	1/2" C, 2#10, #10N, #10G	SPA, SPB
②	1" C, 2#4, #4N, #4G	HPC
③	1" C, 2#3, #3N, #3G	HPA, HPB
④	1-1/4" C, 2#1, #1N, #6G	103, 104, 106, 107, 203, 204, 205, 206, 207, 303, 304, 305, 306, 307, 404, 405, PH4, PH5
⑤	1-1/2" C, 3#1, #1N, #6G	HP
⑥	1-1/2" C, 2#1/0, #1/0N, #6G	102, 202, 308, 403, 405, 407, PH3, PH6
⑦	1-1/2" C, 2#2/0, #2/0N, #6G	101, 201, 302, 402, 40B, PH7
⑧	2" C, 2#3/0, #3/0N, #6G	301, 401, PH1, PH2
⑨	(3) 3-1/2" C, 3#600kcmil, #600kcmil N, #3/0G	MS2
⑩	3" C, 2#500kcmil, #500kcmil N, #3G	EV, EV-2

SIZING METHOD: COPPER, 75%OC #12 AND ABOVE

MAIN SERVICE CALCULATION		
GENERAL LIGHTING LOAD	3 X 51839	= 155517 VA
SMALL APPLIANCE LOAD	49 X 2 X 1500	= 147000 VA
GARBAGE DISPOSAL	49 X 1 X 870	= 42630 VA
LAUNDRY	49 X 1 X 1500	= 73500 VA
DISHWASHER	49 X 1 X 1200	= 58800 VA
MICROWAVE OVEN	49 X 1 X 1200	= 58800 VA
BATHROOM FAN	49 X 2 X 50	= 4900 VA
SMOKE DETECTOR	49 X 4 X 10	= 1960 VA
ELECTRIC DRYER	49 X 1 X 5000	= 245000 VA
ELECTRIC OVEN	49 X 1 X 8000	= 392000 VA
FC-1	49 X 1 X 700	= 34300 VA
HP-1	49 X 1 X 4500	= 220500 VA
25% OF LARGEST LOAD		1125 VA
TOTAL CONNECTED LOAD		1436032 VA
APPLICATION OF OPTIONAL CALC.		0.26
NEC DEMAND FACTOR		373368 VA
AMP @ 208Y/120		1036 A
SWITCHBOARD MS1		684 A
SWITCHBOARD MSB		245 A
SWITCHBOARD MSC		260 A
TOTAL AMP @ 208Y/120		2225 A
SERVICE SIZE REQUIRED:		1-2500A, 208Y/120, 3 PH, 4 WIRE

PANEL R1 LOAD CALCULATION		
LIGHTING LOAD	500 X 3 VA/FT	= 1500 VA
RECEPTACLE LOAD	500 X 1 VA/FT	= 500 VA
SIGN	1 X 1200 VA	= 1200 VA
AC LOAD	2 X 4700 VA	= 9400 VA
FAN COIL LOAD	2 X 700 VA	= 1400 VA
SHOW WINDOW (30 FT.)	1 X 6200 VA	= 6200 VA
MISC. LOAD	25000 VA	= 25000 VA
		45200 VA
		125 AMP
PANEL SIZE REQUIRED:		1-200A, 208Y/120, 3 PH, 4 WIRE
PANEL R2 LOAD CALCULATION		
LIGHTING LOAD	500 X 3 VA/FT	= 1500 VA
RECEPTACLE LOAD	500 X 1 VA/FT	= 500 VA
SIGN	1 X 1200 VA	= 1200 VA
AC LOAD	2 X 4700 VA	= 9400 VA
FAN COIL LOAD	2 X 700 VA	= 1400 VA
SHOW WINDOW (20 FT.)	1 X 4000 VA	= 4000 VA
MISC. LOAD	25000 VA	= 25000 VA
		43000 VA
		119 AMP
PANEL SIZE REQUIRED:		1-200A, 208Y/120, 3 PH, 4 WIRE
TOTAL		245 AMP
TOTAL SWTBD SIZE REQUIRED:		1-400A, 208Y/120, 3 PH, 4 WIRE

SERVICE MSB LOAD CALCULATION		
LIGHTING LOAD	1000 X 3 VA/FT	= 3000 VA
RECEPTACLE LOAD	1000 X 1 VA/FT	= 1000 VA
SIGN	1 X 4800 VA	= 4800 VA
AC LOAD	2 X 4700 VA	= 9400 VA
FAN COIL LOAD	2 X 700 VA	= 1400 VA
SHOW WINDOW (120 FT.)	1 X 24000 VA	= 24000 VA
MISC. LOAD	50000 VA	= 50000 VA
		93600 VA
		260 AMP
SERVICE SIZE REQUIRED:		1-400A, 208Y/120, 3 PH, 4 WIRE
FEEDER CALCULATION TYPICAL UNIT		
GENERAL LIGHTING	3 X 1854	= 5562 VA
SMALL APPLIANCE	2 X 1500	= 3000 VA
LAUNDRY	1 X 1500	= 1500 VA
		10062
		15T 3000 @ 100%
		3000
		REMAINDER @ 35%
		2471.7
GARBAGE DISPOSAL	1 X 870	= 870 VA
DISHWASHER	1 X 1200	= 1200 VA
MICROWAVE OVEN	1 X 1200	= 1200 VA
SMOKE DETECTOR	4 X 10	= 40 VA
HOOD FAN	1 X 150	= 150 VA
BATHROOM FAN	2 X 50	= 100 VA
ELECTRIC DRYER	1 X 5000	= 5000 VA
ELECTRIC OVEN	1 X 8000	= 8000 VA
FC-1	1 X 700	= 700 VA
HP-1	1 X 4500	= 4500 VA
		4900
25% OF LARGEST CONT. LOAD		1225
TOTAL LOAD		28857
AMP @ 208V		139

3700 W. RIVERSIDE INVESTMENTS, LLC  
127 N. MADISON AVE., SUITE 200  
PASADENA, CA 91101

3700 RIVERSIDE DRIVE MIXED-USE PROJECT  
3700 W. RIVERSIDE DRIVE  
BURBANK, CA 91505

CUP & DR SUBMITTAL	2/15/19
CUP & DR - PLAN UPDATES	9/12/19
CUP & DR - RESUBMITTAL	9/26/19

ISSUE DESCRIPTION

SHEET TITLE

**SINGLE LINE DIAGRAM & LOAD CALCULATIONS**

SHEET NUMBER

**E-2.0**







